

| A1 :   | TITLE<br>3D VIEWS  | S  |  |  |
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|  |  | L NOTES  |  |  |
|  |  | TION PLAN  | AN   |  |
| A5   | BASEME   | NT PLAN  |  |  |
|  | GROUND<br>ROOF PL  | FLOOR PLAN   |  |  |
|  |  | RIGHT ELEVA  | ATION  |  |
|  |  | EFT ELEVATION  | ON   |  |
|  |  | SECTION A-A  | C-C  |  |
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| PROJECT  | AREA:  | 81.00  | LIMING   |  |
|  |  | BLDG<br>AREA   | LIVING   |  |
| PROJECT<br>GROUND<br>GARAGE  | FLOOR:   | AREA<br>1295 sqft  |  |  |
| GROUND<br>GARAGE   | FLOOR:   | AREA<br>1295 sqft<br>278 sqft  | AREA   |  |
| GROUND   | FLOOR:   | AREA<br>1295 sqft  | AREA   |  |
| GROUND<br>GARAGE   | FLOOR:   | AREA<br>1295 sqft<br>278 sqft<br>101 sqft  | AREA   |  |
| GROUND<br>GARAGE:<br>VERANDA<br>COVERED<br>DEFINITION:<br>BUILDING ARI<br>above grade w                    | FLOOR:   | AREA<br>1295 sqft<br>278 sqft<br>101 sqft<br>144 sqft<br>al Building Code): the greater<br>auface of exterior walls or w   | AREA<br>1167 sqft  |  |
| GROUND<br>GARAGE<br>VERAND/<br>COVEREI<br>DEFINITION:<br>BUILDING ARI<br>above grade w<br>exterior walls a | FLOOR:<br>CODECK:<br>EA (as per Nation<br>thin the outside s<br>and the centre line  | AREA<br>1295 sqft<br>278 sqft<br>101 sqft<br>144 sqft<br>al Buiding Code): the grea<br>urface of exterior walls or w<br>of firewalls. Used for cost                                | AREA<br>1167 sqft<br>test horizontal area of a<br>whin the outside surface<br>estimate, building permi                             |  |
| GROUND<br>GARAGE:<br>VERANDA<br>COVEREI<br>DEFINITION:<br>BUILDING AREA:<br>LIVING AREA:                   | FLOOR:<br>C.<br>DECK:<br>EA (as per Nation<br>thin the outside s<br>and the centre line<br>area that will be                           | AREA<br>1295 sqft<br>278 sqft<br>101 sqft<br>144 sqft<br>al Building Code): the greater<br>auface of exterior walls or w   | AREA<br>1167 sqft<br>fest horizontal area of a<br>(thin the outside surface<br>estimate, building permi<br>floor space under cabin |  |
| GROUND<br>GARAGE:<br>VERANDA<br>COVEREI<br>DEFINITION:<br>BUILDING AREA:<br>LIVING AREA:                   | FLOOR:<br>CODECK:<br>EA (as per Nation<br>thin the outside s<br>and the centre line<br>area that will be<br>taircase opening.<br>CANT: | AREA<br>1295 sqft<br>278 sqft<br>101 sqft<br>144 sqft<br>al Buiding Code): the grea<br>urface of exterior walls or w<br>of firewalls. Used for cost<br>heated or cooled, including | AREA<br>1167 sqft<br>fest horizontal area of a<br>(thin the outside surface<br>estimate, building permi<br>floor space under cabin |  |

# Paragon Homes Intellectual Property on Home

## Designers / Plans

### 1. ARCHITECTURAL DESIGN

francis@blengineering.ca

File:

It is important to understand that the design and plan which was produced on your behalf by Paragon were designed with a home package-kit structural system. It includes our <u>exclusive</u> wall system which has an R-32 insulation factor. Those plans were also produced with complete structural engineering, mechanical engineering, pre-engineered roof trusses, pre-engineered floor system and a very custom home via and with Paragon home package-kit.

Production of your home package-kit will begin, and we need 6 to 8 weeks to produce all elements included in your home package-kit.

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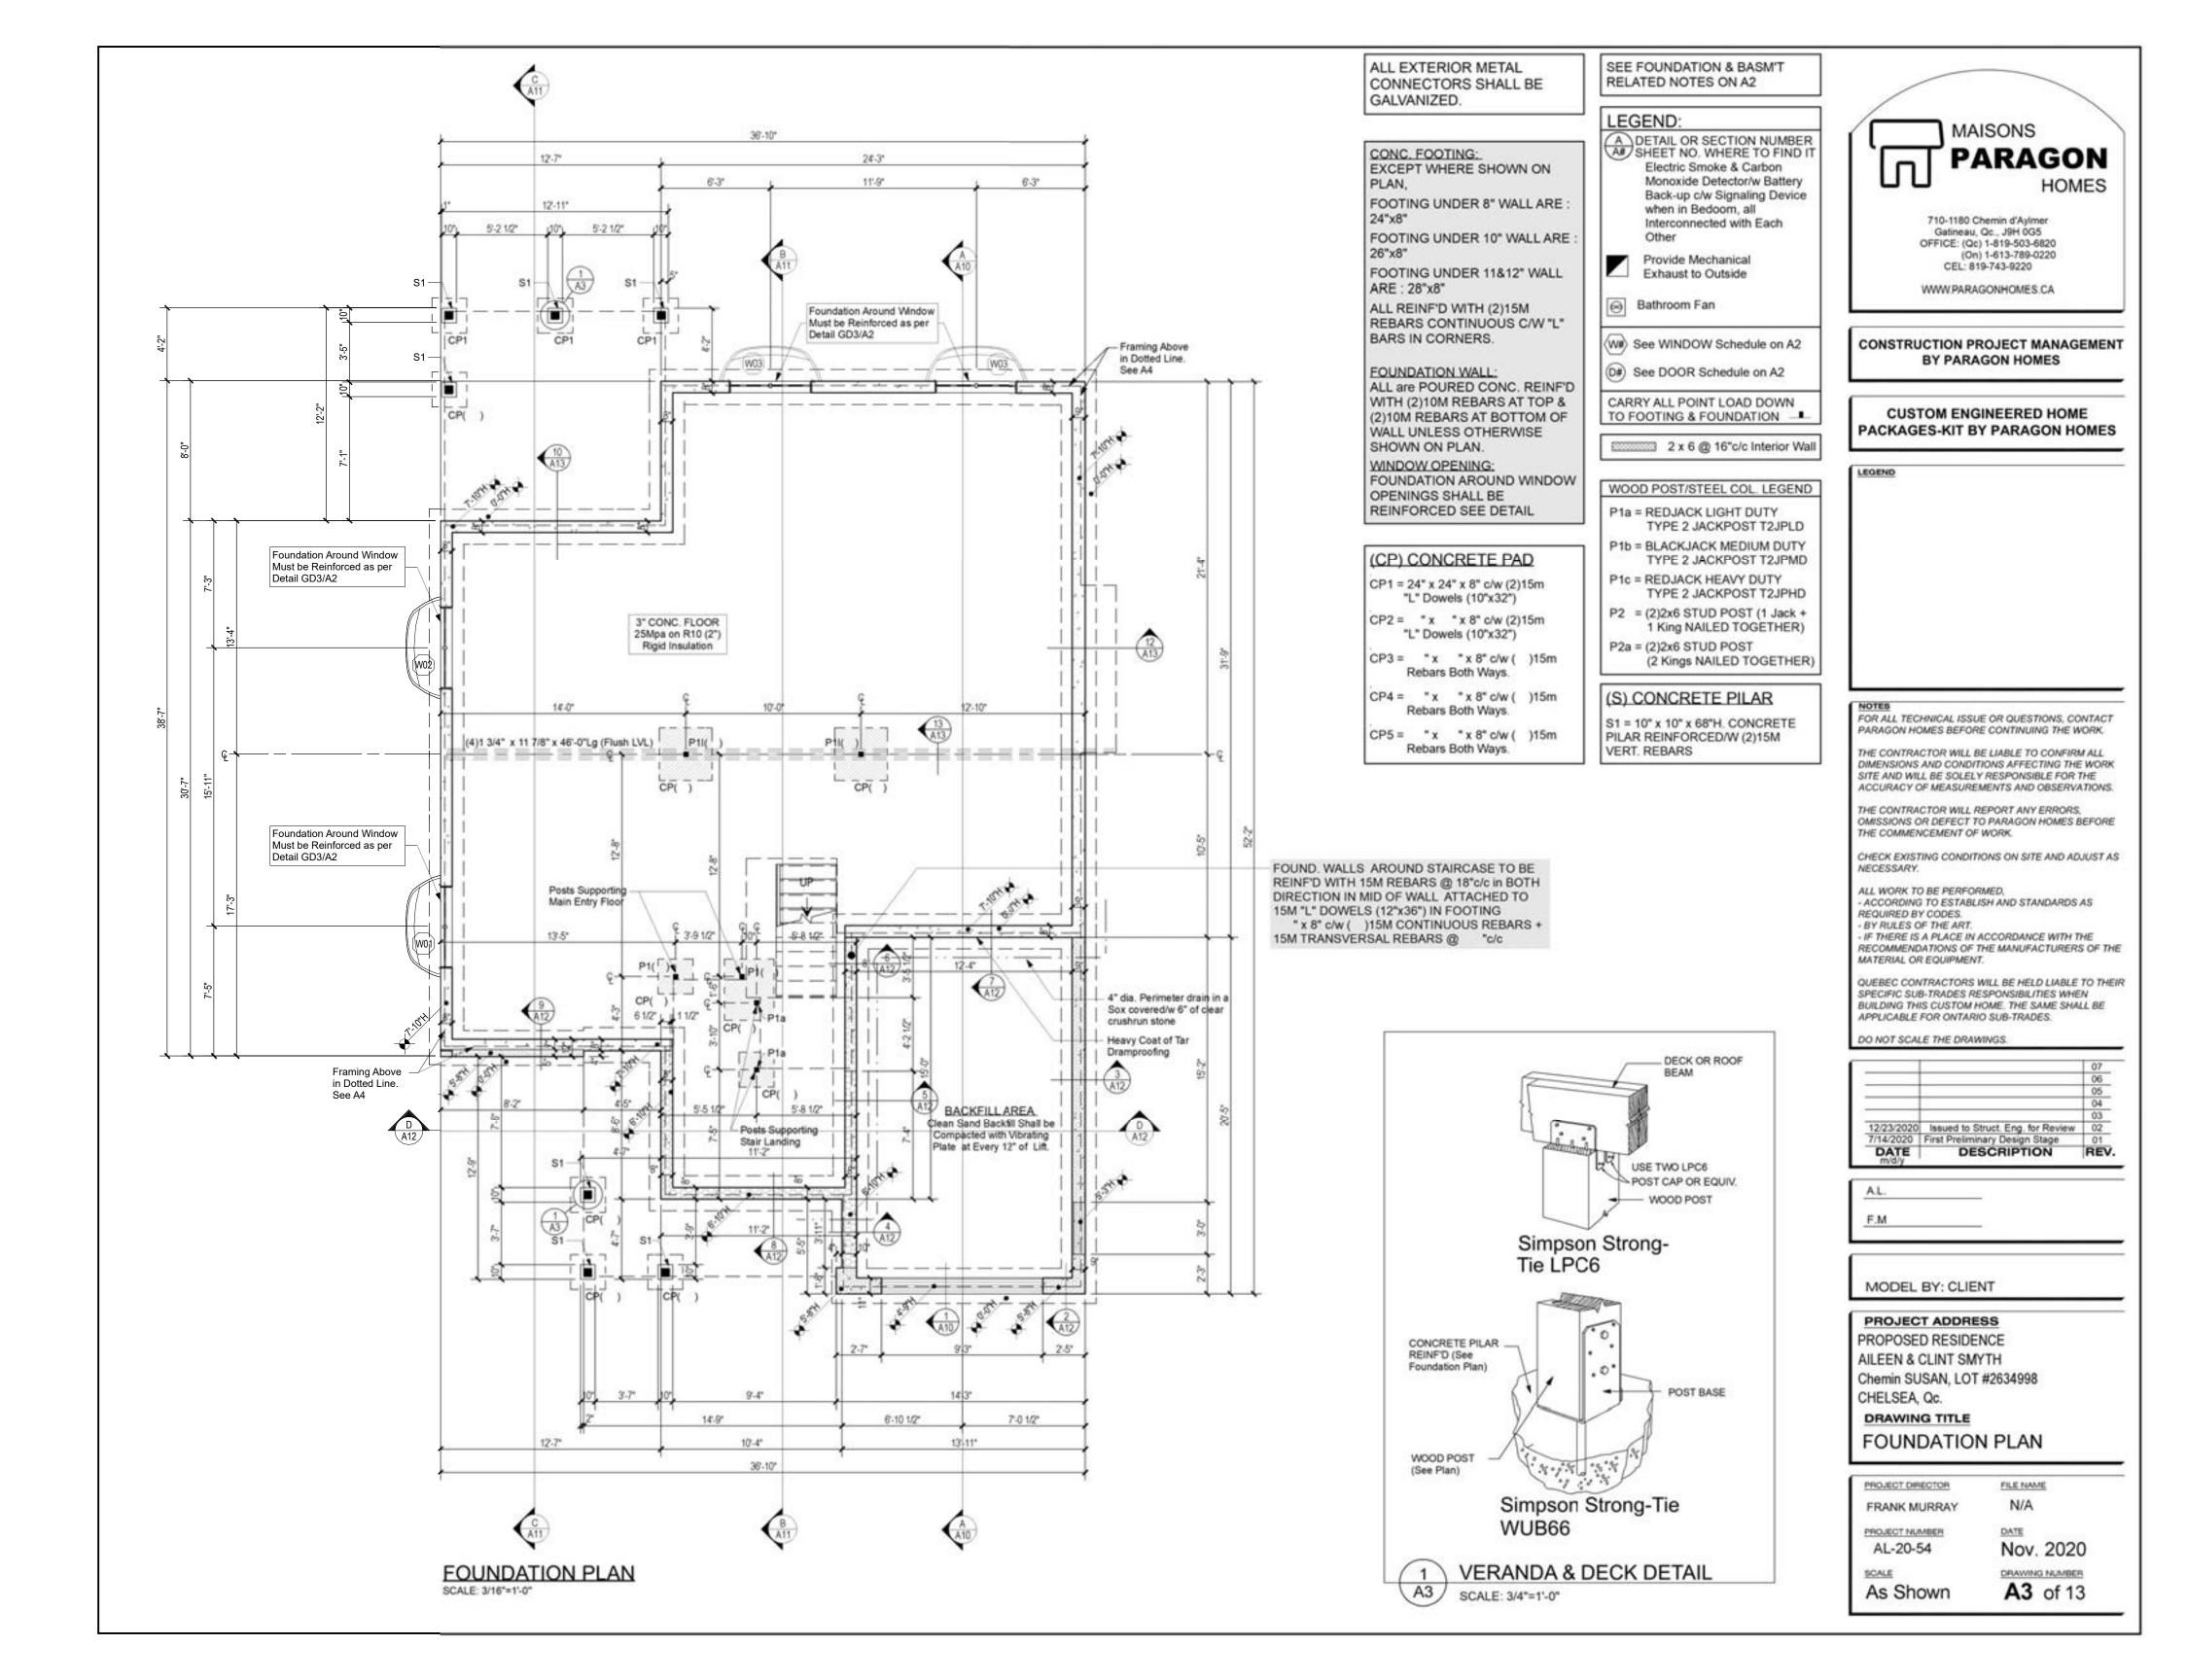
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| Gatineau,<br>OFFICE: (Qc)<br>(On)   | hemin d'Aylmer<br>Qc., J9H 0G5<br>1-819-503-6820<br>1-613-789-0220<br>9-743-9220   |
|   | GONHOMES.CA  |
|   | OJECT MANAGEME   |
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| SITE AND WILL BE SOLELY   | IONS AFFECTING THE WOI<br>RESPONSIBLE FOR THE<br>MENTS AND OBSERVATION   |
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| MATERIAL OR EQUIPMENT<br>QUEBEC CONTRACTORS   |  |
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| CHELSEA, Qc.<br>DRAWING TITLE   |  |
| 3D VIEW   |  |
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| FRANK MURRAY  | FILE NAME<br>N/A   |
| PROJECT NUMBER  |  |
| The second s  | DATE   |
| AL-20-54  | Nov. 2020  |


| IMPORTANT NOTES BAS   | SEMENT NOTES   | FOUNDATION NOTES  |   | ABBREVIATIONS  |   |   |   |
|---|--|---|---|--|---|---|---|
| CODES & STANDARDS CARPENTRY BN1> 4"Ø  | WEEPING TILE IN A SOX TO   | SOIL BEARING  | N1> ALL EXTERIOR WALLS ARE IN 246   | A.A. ATTIC ACCESS<br>ABV ABOVE   | A DETAIL OR SECTION NUMBER  | N   |   |
| - ALL WORKMANSHIP IS TO BE OF A STANDARD BETTER UNLESS OTHERWISE SPECIFIED ON PLAN, OF  | INSTALLED AT THE PERIMETER<br>FTG. AND COVERED/W 6" OF<br>EAR CRUSHRUN STONE                           | ALL FOOTING AND PADS MUST BE<br>CARRIED DOWN TO ELEVATIONS  | STUDS @ 16"c/c AND ALL INTERCOR<br>WALLS ARE IN 2x4 STUDS @<br>UNLESS OTHERWISE SPECIF        | A.B. ANCHOR BOLT<br>B.F. BI FOLD<br>BLK. BLOCK   | AR SHEET NO. WHERE TO FIND IT<br>Electric Smoke & Carbon<br>Monoxide Detector/w Battery               |   | MAISONS   |
| - AT THE TIME OF PREPARATION, THIS PLAN WAS<br>DRAWN IN ACCORDANCE WITH THE CURRENT<br>FOR THE AUTOMATIC AND THE DUR DRAWN OF A THE COMPACT AND THE AUTOMATIC AUTOMATIC AND THE AUTOMATIC AUTOMATIC AND THE AUTOMATIC AUTOMATIC AND THE AUTOMATIC AUTOMATIC AUTOMATIC AND THE AUTOMATIC AU  | IL VAPOR BARRIER SHALL BE  | SPECIFIED ON UNDISTURBED SOIL<br>HAVING 1567 PSF (75 KPa) BEARING<br>CAPACITY. ALLOWABLE SOIL                 | N2> NAT. GAS FIREPLACE MANUE SPECS  | BLW. BELOW<br>BW BOTH WAYS<br>B.P. BEAM POCKET 3 1/2*  | Back-up c/w Signaling Device<br>when in Bedoom, all   | WINDOW  |   |
| IS THE RESPONSIBILITY OF THE OWNER/BUILDER  | AB EXCEPT IF UNDER SLAB IS<br>SULATED WITH RIGID INSUL.  | BEARING MUST BE CONFIRMED BY A<br>GEOTECHNICAL ENGINEER.  | SHALLL BE LEFT ON SITE FOR<br>INSPECTOR. (IF FIREPLACE IS INSTALLED)                          | CATH CATHEORAL   | Interconnected with Each<br>Other   | ROUGH   |   |
| INCORPORATED IN THE CONSTRUCTION. ALL<br>WORK SHALL CONFORM TO BYLAWS, SHALL BE BRIDGED AT MID SPAN OR AT 7 FT. O.C. BN3> MO  | DISTURE BARRIER IS REQ'D<br>TWEEN WOOD & CONCRETE  | POURED CONCRETE   | N3> INSULATE AND CONTINUE WARDUR<br>BARRIER WHERE INTERIOR WALLS<br>MEETS WITH EXTERIOR WALLS | CIG. CELING<br>COL. COLUMN<br>CONC. COLUMN<br>CONC. CONCRETE<br>CSMT. CASEMENT<br>CC. CENTER               | Provide Mechanical<br>Exhaust to Outside  | 8*  | - HOMES   |
| - PRIOR TO PROCEEDING WITH CONSTRUCTION, THE WITH WOOD. BRIDGING SHALL BE 2x2 DIAGONAL TYPE UNI   | LESS P/T WOOD IS USED.   | A> CONCRETE WORK SHALL CONFORM TO<br>CSA CAN3-A23.1,2,3 WITH MAXIMUM  | N4> PROVIDE CAULKING AT ALL EXTERIOR  | C/W COMPLETE WITH<br>DBL DOUBLE  | Fan - Exhaust to Outside  |   | 710-1180 Chemin d'Aylmer<br>Gatineau, Qc., J9H 0G5  |
| AND SPECIFICATIONS WRITTEN. DIMENSIONS ALWAYS<br>TAKE PRECEDENCE OVER SCALE MEASUREMENTS. 1/2" ANCHOR BOLTS @ 72" MAXIMUM SPACING. INS  | L RIM JSTS SHALL BE<br>STALLED OVER FOUNDATION<br>LL PARALLEL TO FLOOR JSTS                            | AGGREGATE SIZE OF 3/4"(20mm) AND<br>ULTIMATE STRENGTH AT 28 DAYS OF:<br>- 20 Mpa (2900 PSI) WALLS & FTG       | WALL FRAMING WHERE FRAMING<br>MEMBERS ABUT.   | DECO. DECORATIVE<br>DIA. DIAMETER<br>DISP. DISPOSAL<br>DJ. DOUBLE JOISTS                                   | 2x6 Mechanical Wall   |   | OFFICE: (Qc) 1-819-503-6820<br>(On) 1-613-789-0220<br>CEL: 819-743-9220   |
| FIGATIONS OR FROM CONDITIONS ENCOUNTERED AT<br>THE JOB SITE, SHALL BE RESOLVED BY THE OWNER/ WITH JOIST HANGERS UNLESS OTHERWISE SPECIFIED.   | T WATER TANK SHALL BE<br>CURED TO HOUSE STRUCTURE  | - 20 Mpa (2900 PSI) WALLS & FTG<br>- 25 MPa (3625 PSI) BASEM'T SLAB<br>- 32 MPa (4650 PSI) GARAGE & EXT. SLAB | N5> ALL HOSE BIB SHALL HAVE A BACK<br>FLOW PREVENTER.   | DRJ DOUBLE RIM JOISTS<br>DR, DOOR<br>DW DISH WASHER  | CARRY ALL POINT LOAD DOWN<br>TO FOUNDATION  | Tuarenno  | WWW.PARAGONHOMES.CA   |
| SOLE RESPONSIBILITY.  | ATING & MECHANICAL VENTILATION   | B> FOR CONCRETE EXPOSED TO CYCLES OF<br>FROST AND DEFROST, ENTRAINED AIR                                      | N6> ALL TOILET SHALL BE 6 LITRES PER<br>FLUSH MAXIMUM. ADD BLOCKING IN                        | E.E. EACH END<br>ELEC. ELECTRICAL  | WOOD POST/STEEL COL. LEGEND   | WATERPROOFING<br>MEMBRANE TO BE INTALLED          |   |
| BY INTERIM STORAGE OF MATERIALS SHALL NOT BE VENTILATION COLOR  | STEM SHALL BE INSTALLED AS PER<br>DE AND MANUFACTURER'S SPECS<br>ALL BE LEFT ON SITE.                  | MUST BE BETWEEN 4.5 to 7% AND AS<br>PER CAN3-A266.1 M78   | WALL NEAR TOILET, SHOWER AND<br>BATH TUB FOR FUTUR GRAE<br>PER BARRIER FREE DESIGN RECORDINGS | ELEV. ELEVATION<br>EXT. EXTERIOR<br>EXIST. EXISTING  | When NOT SPECIFIED, Standard<br>Support (BOTH END) of Header  | AFTER AIR BARRIER WRAP<br>AND PRIOR TO INSTALL    | CONSTRUCTION PROJECT MANAGEMENT   |
| PORARY SUPPORT FOR WALLS AND FLOORS PRIOR<br>TO THE COMPLETION OF VERTICAL AND LATERAL<br>TO THE COMPLETION OF VERTICAL AND LATERAL<br>WALLS AND CHILINGS BETWEEN RESIDENCE AND   | .C. Sec. 9.9.10.1.(1) EXIT WINDOW<br>SEMENT) Shall be Openable from the                                | C> CONCRETE IS TO HAVE A<br>MAXIMUM SLUMP OF 100mm (4").  | N7> HOT WATER SUPPLIED TO FIXTURES  | F.G. FINISH GRADE<br>F.R. FIRE RATED<br>FIN. FINISHED  | Above Openings in Load Bearing<br>Stud Wall is 1 JACK and 1 KING.                                     | WINDOW  | BY PARAGON HOMES  |
| THE OWNER/BUILDER SHALL BE RESPONSIBLE FOR - ALL ROOF SPACES SHALL BE VENTILATED WITH an I  | de Without the Use of Tools and Provides<br>Individual Unobstructed Open Portion                       | D> FOR NORMAL STRUCTURAL CONCRETE<br>FULL CURING PERIOD IS 28 DAYS.<br>IF FOR ANY REASON. THE CONTRACTOR      | SHALL NOT EXCEED 49%%D. (MIXING VALVE)<br>N8> ALL DOORS GIVING DIRECT ACCESS TO               | FL FLOOR<br>FW FOUNDATION WALL   | P1 = "x "x 1/4" HSS POST  | (GD2) WINDOW SILL<br>A2) DAMPROOFING              |   |
| PROPERTY. BETWEEN THE TOP OF ROOF SPACE AND SOFFITS Dim<br>THE OWNER/BUILDER TO SUPPLY ALL MISSING AS SHOWN ON ELEVATION DWG. Dim   | ing a Minimum Area of 0.35m2 with no nensions Less than 380mm.   | NEEDS TO DISMANTLE THE FORMWORK<br>OR APPLY ANY ADDITIONAL LOADS  | HOUSE FROM OUTSIDE SHALL BE<br>EQUIPPED WITH DEADBOLT LOCK<br>PROVIDE SOLID BLOCKING ON BOTH  | G.T. GIRDER TRUSS<br>GA. GAUGE<br>GALV. GALVANIZED<br>GL. GLASS  | P1a = REDJACK LIGHT DUTY  | DAWFROOFING                                       | CUSTOM ENGINEERED HOME<br>PACKAGES-KIT BY PARAGON HOMES   |
| LOT, LEGAL DESCRIPTION, NORTH DIRECTION, MAIN   | en the Window Opens into a Window Well<br>learance of 22" (550mm) shall be provided<br>ront of Window. | BEFORE CURING PERIOD IS OVER<br>HE MUST GET A WRITTEN CONSENT   | SIDE OF DOOR JAMBS AT LOCKING OF THE STATE  | GS. GIRDER SUPPORT<br>HGT. HEIGHT  | TYPE 2 JACKPOST<br>T2JPLD   |   | PACKAGES ATT BT PARAGON HOMES   |
| - THE OWNER/BUILDER TO BE RESPONSIBLE FOR ROOF ≤40ft 38 P5F 19 P5F<br>CONDITIONS SUCH AS SOIL BEARING CAPACITY, ROOF >40ft 46 P5F 19 P5F  |  | FROM A STRUCTURAL ENGINEER.<br>E> NO LIVE LOAD OR DEAD LOAD OTHER   | N9> DOOR GIVING ACCESS FROM GARAGE  | HORIZ HORIZONTAL<br>HR HOUR<br>H.E. HOOD EXHAUST   | P1b = BLACKJACK MEDIUM DUTY<br>TYPE 2 JACKPOST  | L 2.0" W01.W02.W03 2.0" L                         | LEGEND  |
| DEPTH OF FROST PENETRATION, WATER TABLE OR FLOOR 40 PSF 15 PSF<br>BURIED STRUCTURES, ETC INTERIOR STAIR 40 PSF<br>BALCONY, DECK 40 PSF 10 PSF   |  | THAN THE OWN WEIGHT OF THE<br>CONCRETE ELEMENT SHALL BE<br>APPLIED DURING CURING PERIOD.                      | TO HOUSE SHALL BE METAL INSUL<br>COMPLETE/W SELF CLOSER DEADBOLT<br>AND WEATHERSTRIP          | INSUL INSULATION<br>INT. INTERIOR  | T2JPMD<br>P1c = REDJACK HEAVY DUTY  | Window 1  |   |
| MISCELLANEOUS   |  | F> CONTRACTOR MUST GIVE ENGINEER<br>24H. WRITTEN NOTICE BEFORE POURING  | N10> ALL OPENING IN RAILING & GUARDS<br>SHALL BE DESIGNED TO PREVENT THE                      | JST JOISTS<br>JH JOIST HANGER<br>KIT. KITCHEN  | TYPE 2 JACKPOST<br>T2JPHD   |   |   |
| - DOORS & WINDOWS TRIM, FLOOR FINISHES, VANITIES,<br>BATH SPLASH AND KITCHEN CABINETS TO MEET<br>SPECIFICATIONS OF OWNER/BUILDER.   |  | CONCRETE WHEN ENG. SEAL IS ON PLAN<br>G> REINFORCING STEEL MUST MEET  | PASSAGE OF A 4" DIA. SPHERE AND<br>PREVENT CLIMBING.  | LG LONG<br>UN UNEN<br>LT LIGHT   | P2 = (2)2x6 STUD POST (1 Jack +<br>1 King NAILED TOGETHER)  | Foundation (2)15M Rebar (Typ.)                    |   |
| - APPROVED LOCKING MEDICINE CABINET TO BE<br>INSTALLED IN AT LEAST ONE BATHROOM. FIN. GRADE   |  | CSA G30.18 AND REINFORCING<br>WELDED WIRE FABRIC MUST MEET<br>G30.3 AND IS SUPPLIED IN SHEETS                 | N11> DIVIDING WALL BETWEEN GARAGE<br>AND HOUSE SHALL BE COVERED                               | LVL LAMINATED VENEER LUMBER<br>M.C. MEDICINE CABINET   | P2a = (2)2x6 STUD POST<br>(2 Kings NAILED TOGETHER)   | 1 (2)15M Rebar (Typ.)                             |   |
| COAT AND CLOTHES CLOSET SHALL HAVE AT LEAST     ONE ROD AND SHELF. LINEN CLOSET SHALL HAVE     SADJUSTABLE SHELVES WHEREVER POSSIBLE.   | (2)15M REBARS CONTINUOUS   | G30.3 AND IS SUPPLIED IN SHEETS<br>H> ALL REBARS MUST BE 400 Mpa (60 Ksi),<br>CLEAN OF ANY DIRT, AND LAID     | WITH 1/2" DRYWALL ON BOTH SIDE  | MECH. MECHANICAL<br>M.R.H. MEAN ROOF HEIGHT<br>M.T. METAL THRESHOLD  | P3 = (3)2x6 STUD POST (2 Jack +<br>1 King NAILED TOGETHER)  |   |   |
| BROOM CLOSET SHALL HAVE ONE SHELF.  | AT TOP C/W 15M "L" BARS<br>(24"x24") IN CORNERS  | AS SHOWN ON DRAWINGS.<br>REBARS CONC. COVER   | IN GARAGE(TYP. FOR WALL & CEILIG)<br>N12> WALL STUDS SHALL BE CONTINUOUS                      | MAX. MAXIMUM<br>MFR. MANUFACTURER<br>M/W MICROWAVE<br>MIN. MINIMUM   | P3a = (3)2x6 STUD POST<br>(3 Kings NAILED TOGETHER)   |   |   |
| AROUND BATHTUBS OR SHOWERS SHALL BE APPLIED<br>OVER MOISTURE RESISTANT BACKING.<br>BLUESKIN WATERPROOF  |  | I> MIN. CLEAR COVER SHALL BE:<br>A) CAST AGAINST AND PERMANENTLY  | FOR THE FULL STOREY HEIGHT EXCEPT<br>AT OPENINGS.   | MTL METAL<br>O.H.D. OVER HEAD DOOR   | P4 = (4)2x6 STUD POST (3 Jack +<br>1 King NAILED TOGETHER)  | GD3 EOUNDATION WALL REINFORCEMT                   |   |
| GLASS & WINDOWS<br>- GLASS SLIDING PATIO DOORS ARE TO BE OF MEMBRANE ON AQUABLOC<br>PRIMER (PER MANUF. SPECS)   |  | EXPOSED TO EARTH: 75mm (3")<br>B) EXPOSED TO EARTH OR WEATHER:  | N13> INDIVIDUAL MEMBER OF BUILT UP<br>LINTELS SHALL BE FASTENED TOGETHER                      | PL PLATE<br>PL.F. POUNDS PER LINEAR FOOT<br>P.S.F. POUNDS PER SQUARE FOOT<br>P.S.I. POUNDS PER SQUARE INCH | P4a = (4)2x6 STUD POST<br>(4 Kings NAILED TOGETHER)   | A2 AI WINDOW: W01 W02 & W03<br>SCALE: 3/16"=1'-0" | NOTES   |
| TEMPERED GLASS.<br>- ALL WINDOWS SHALL BE AS PER WINDOWS<br>SCHEDULE.<br>- ALL WINDOWS SHALL BE AS PER WINDOWS<br>- ALL WINDOWS |  | - 20M TO 55M BARS 50mm (2")<br>- 15M BARS, 16mm WIRE<br>AND SMALLER 40mm (1 1/2")                             | WITH A MIN. OF 3 1/2" NAILS IN A DOUBLE<br>ROW SPACED @ 17 3/4" O.C. MAX                      | P.T. PRESSURE TREATED<br>PARTN. PARTITION  | P5 = 4x4 WOOD POST P/T<br>P6 = 6x6 WOOD POST P/T  |   | FOR ALL TECHNICAL ISSUE OR QUESTIONS, CONTACT<br>PARAGON HOMES BEFORE CONTINUING THE WORK.  |
| HEATING & VENTILATION   |  | AND SMALLER 40mm (1 1/2")<br>J> OVERLAPPING OF REBARS SHALL BE:<br>- FOR 15M AND SMALLER = 500mm (20")        | N14> FRAMER TO REFER TO FLOOR JOIST<br>MANUFACTURER'S PLAN FOR DETAILS                        | PKT POCKET<br>PLYWD. PLYWOOD<br>R.O. ROUGH OPENING   | P7 = 5 1/4" x 5 1/4" PSL<br>TIMBER POST   |   | THE CONTRACTOR WILL BE LIABLE TO CONFIRM ALL  |
| - BUILDER OR HEATING CONTRACTOR TO PROVIDE HEAT<br>LOSS CALCULATIONS AND LAYOUT.<br>THE MECHANICAL & ELECTRICAL DESIGN SHALL BE THE   | (2)15M REBARS CONTINUOUS<br>AT BOT. C/W 15M "L" BARS<br>(24"x24") IN CORNERS                           | - FOR 20M AND BIGGER = 600mm (24")<br>K> IN WALLS, PROVIDE CORNER REBARS                                      | IF WOOD I JOISTS ARE TO BE USED<br>N15> RANGE/COOKTOP HOOD & DRYER                            | S.A. STEEL ANGLE<br>S.B. SOLDIER BRICK   | If Header is NOT Tight Under Top<br>Plates, Solid Blocking to Match                                   |   | DIMENSIONS AND CONDITIONS AFFECTING THE WORK<br>SITE AND WILL BE SOLELY RESPONSIBLE FOR THE<br>ACCURACY OF MEASUREMENTS AND OBSERVATIONS. |
| 4" DIA. PERIMETER DRAIN IN<br>RESPONSIBILITY OF THE MECHANICAL AND ELECTRICAL<br>CONTRACTOR. IT IS THE RESPONSIBILITY OF THE<br>CONTRACTORS TO ENSURE THAT THEIR DISCIPLINE WERE  | 2" (R10) RIGID INSUL. @<br>SLAB PERIMETER  | OF 600mm x 600mm (24" x 24")<br>SPACED SAME AS WALL REINFORCEM'T.   | SHALL BE EQUIPPED WITH EXHAUST<br>DUCT LEADING TO OUTSIDE                                     | S.C. SOLID CORE<br>S.G.D. SLIDING GLASS DOOR<br>SF SQUARE FOOT   | Support shall be installed at Ends.   |   | THE CONTRACTOR WILL REPORT ANY ERRORS.  |
|   |  | STEEL ANGLES FOR MASONRY VE   | NEER (Table 9.20.5.2.B)<br>XT. ANGLES FOR 4" BRICK & STONE                                    | SH SINGLE HUNG<br>SL SIDELIGHT<br>S.S.T. SIMPSON STRONG TIES   | HEADER LEGEND:  |   | OMISSIONS OR DEFECT TO PARAGON HOMES BEFORE<br>THE COMMENCEMENT OF WORK.  |
| INSTALLATION OF ELECTRICAL ITEMS MUST COMPLY<br>WITH LOCAL ELECTRICAL CODES AND REGULATIONS   | (2)15M REBARS CONTI.<br>CONTI. IN FTG.   | L1 ≤ 2.30m _< 7'-6" (90") L 89 x  | 89 x 6.4         L 3 1/2" x 3 1/2" x 1/4"           x 89 x 6.4         L 4" x 3 1/2" x 1/4"   | ST. STIRRUPS<br>STL STEEL<br>SW SWTCH<br>SWC SOLID WOOD CORE   | All Header To Be (2)2x10 with P2<br>UNLESS OTHERWISE NOTED.   |   | CHECK EXISTING CONDITIONS ON SITE AND ADJUST AS<br>NECESSARY.   |
| IN ALL RESPECTS.<br>OUTLET LOCATIONS IF SHOWN ON PLANS COMPLY WITH<br>CODE DECIMPENTER AND ADD TO DE MISER AS A<br>FOR FTG. SIZE  | E INFO. SEE FOUNDATION PLAN  | L3 3.08m 10'-0" (120") L 127  | x 89 x 7.9 L 5" x 3 1/2" x 5/16"  | TH THICK<br>T.O.FD. TOP OF FOUNDATION  | H1=(2)2x12 H4=(2)2x10 H7=(2)2x8<br>H2=(3)2x12 H5=(3)2x10 H8=(3)2x8<br>H3=(4)2x12 H5=(4)2x10 H9=(4)2x8 |   | ALL WORK TO BE PERFORMED.<br>- ACCORDING TO ESTABLISH AND STANDARDS AS  |
| CODE REQUIREMENTS AND ARE TO BE USED AS A<br>GUIDE ONLY. ADJUST ACCORDING TO OWNERS OR<br>LOCAL AUTHORITIES REQUIREMENTS.   | FORCEMENT  | L5 3.33m 10'-11" (131") L 127   | x 89 x 11 L 5" x 3 1/2" x 7/16"<br>x 89 x 13 L 5" x 3 1/2" x 1/2"                             | T.O.FTG.TOP OF FOOTING<br>T.O.PL. TOP OF WOOD PLATE<br>TJ. TRIPLE JOISTS                                   | H10=(2)2x6 H11=(3)2x6 H12=(4)2x6  |   | REQUIRED BY CODES.<br>- BY RULES OF THE ART.  |
| BATHROOM FANS SHALL BE 60 CFM AND ALL EXHAUST<br>FAN TO BE C/W THERMAL INSULATION 1" (25mm)<br>THICK AND ANTI-SWEAT VAPOUR BARRIER.     P.S.: FOR WALL <u>NOT</u> LATERALLY SUPPOR<br>Around Stair in a Garage or Kneewall on a Fe  |  |   | x 89 x 11 L 6" x 3 1/2" x 7/16"<br>x 89 x 13 L 6" x 3 1/2" x 1/2"                             | TYP. TYPICAL<br>US UNDERSIDE<br>VERT. VERTICAL   |   |   | <ul> <li>IF THERE IS A PLACE IN ACCORDANCE WITH THE<br/>RECOMMENDATIONS OF THE MANUFACTURERS OF THE<br/>MATERIAL OR EQUIPMENT.</li> </ul> |
| on Plan)  | ,<br>  |   | x 102 x 13 L 6" x 4" x 1/2"<br>x 102 x 11 L 7" x 4" x 7/16"                                   | W/ WITH<br>WC WATER CLOSET   |   |   | QUEBEC CONTRACTORS WILL BE HELD LIABLE TO THEIR   |
|   | SCALE: N.T.S. GD1  | L10 4.25m 13'-11" (167") L 178  | x 102 x 13 L 7" x 4" x 1/2"   | WD. WOOD   |   |   | SPECIFIC SUB-TRADES RESPONSIBILITIES WHEN<br>BUILDING THIS CUSTOM HOME. THE SAME SHALL BE<br>APPLICABLE FOR ONTARIO SUB-TRADES.           |
|   |  |   |   |  |   |   | DO NOT SCALE THE DRAWINGS.  |
| WINDOW SCHEDULE<br>W# FLR ROOM NAME QTY DIMENSIONS DESCRIPTION COMMENTS AREA<br>(SOLT)  | D# FLR ROOM NAME   | DOOR LEAF   | COMMENTS  |  | WING  |   | 07  |
| WV A II         DOUBLE         DOUBLE         DOUBLE           W01         0         BEDRM #4         1         56"X30"DC         CASEMENT-LHL         11.67  | D01 1 ENTRY/VERANDA  | 1 68 7/8" X 95" MULLED LINE   | MTL INSUL. C/W 3/4 GLASS KEY IN K   | NOB & DEADBOLT/W   | DE  |   | 06<br>05<br>04  |
| TO MEET EGRESS           W02         0         BEDRM #3         1         56"X30"DC         CASEMENT-LHL         11.67  |  | (30 X80 )   | WEATHERSTRIP, (2) SIDE<br>MTL INSUL. C/W 3/4 GIASS KEY IN K                                   | NOB & DEADBOLT/W   |   |   | 12/23/2020 Issued to Struct. Eng. for Review 02   |
| W02     0     DEDITIVITION     1     S0 X00 DO     ONE TO MEET EGRESS       W03     0     FAMILY     2     56"X30"DC     DOUBLE<br>CASEMENT-LHL     11.67   | D02 1 GARAGE   | 1 32"X80" HINGED  | LATCHSTRIKE, 1 1/2 PAIR OF HIM<br>WEATHERSTRIP<br>MTL INSUL OVERHEAD DOOR CW GARA             |  |   |   | 7/14/2020 First Preliminary Design Stage 01 DATE DESCRIPTION REV.   |
| W04     1     ENTRY/<br>VERANDA     1     30"X36"     FIXED GLASS-AT     5.88   | D03 1 GARAGE D04 1 CLOSET/ENTRY  | 1 9'X8' OHD GARAGE<br>1 60"X80" SLIDER  | KIT   | SBO IN   |   |   |   |
| W05     1     LIVING/<br>VERANDA     1     30"X63"SC     SINGLE<br>CASEMENT-HR     LITES IN BETWEEN<br>GLASS PANE     13.12       W06     1     UNING     2     20"X63"SC     SINGLE     LITES IN BETWEEN     13.12   | D05 1 ENTRY/GARAGE<br>D06 1 DINING/COVERED DECK  | 1 32"X80" HINGED  | MTL INSUL. C/W KEY IN K OF A DEADEOL<br>1 1/2 PAIR OF HINGES, DOOR SOL A MEAT<br>PATIO DOOR   |  |   |   | AL.   |
| W00 1 LIVING 2 SU X03 SC CASEMENT-HL GLASS PANE 13.12   | D07 1 HALL/W.I.P.  | 1 24"X80" HINGED  | HOLLOW DOOR, 1 PAIR OF HINGES, PASS<br>STRIKE   | SBO  |   |   | <u>F.M</u>  |
| W08         1         KITCHEN         1         30"X40"SC         SINGLE<br>CASEMENT-HL         LITES IN BETWEEN<br>GLASS PANE         8.33   | D08 1 LNDRY/HALL   | 1 32"X80" HINGED  | HOLLOW DOOR, 1 PAIR<br>LATCH STRIKE<br>HOLLOW DOOR, 1 PAIR                                    | SBU IN   | TOP OF THE RADON -<br>CONDUIT SEALED AN   |   |   |
| W09     1     MASTER BDRM     1     60"X63"DC     DOUBLE<br>CASEMENT-LHL     LITES IN BETWEEN<br>GLASS PANE     26.25       W40     4     DATU     4     CONVADIDG     DOUBLE     LITES IN BETWEEN     20.0   | D09 1 BEDRM #2/HALL D10 1 CLOSET BEDRM #2/BEDRM  | 1 30"X80" HINGED  | LATCH STRIKE<br>HOLLOW DOOR, 1 PAIR CE HINGES, PASS   | SBU IN   | CLEARLY LABELED   | CENTER OF THE                                     | MODEL BY: CLIENT  |
| WIU I BATH I OUX48 DC CASEMENT-LHL GLASS PANE 20.0  | D10 1 CLOSET BEDRIN #2/BEDRIN  | 1 30"X80" HINGED  | STRIKE<br>HOLLOW DOOR, 1 PAIR OF HINGES, PRU<br>LATCH STRIKE                                  | VACY LOCKSET WITH SBO  | SEALED  | CEMENT SLAB                                       | PROJECT ADDRESS   |
| W11         1         BEDRM #2         1         60"X60"DC         CASEMENT-LHL         GLASS PANE         25.0           TOTALS:   | D12 1 MASTER BDRM/HALL   | 1 30"X80" HINGED  | HOLLOW DOOR, 1 PAIR OF HINGES, PRI<br>LATCH STRIKE  | VACY LOCKSET WITH SBO IN   |   | BASEMENT SLAB                                     | PROPOSED RESIDENCE  |
| 1- REFER TO ELEVATIONS FOR WINDOW STYLE BUT NOTE THAT THE EXACT WINDOW STYLE SHALL BE<br>CONFIRM BY THE HOME OWNERS PRIOR TO ORDERING OR MANUFACTURING. SHOP DRAWINGS SHALL BE  | D13 1 MASTER BDRM/CLOSET M/<br>D14 0 BATH/HALL   | ASTER BEDRM 2 60"X80" SLIDER<br>1 30"X80" HINGED  | HOLLOW DOOR, 1 PAIR OF HINGES, PRI<br>LATCH STRIKE  | VACY LOCKSET WITH SBO IN   | GRANULAR  |   | AILEEN & CLINT SMYTH<br>Chemin SUSAN, LOT #2634998  |
| PROVIDED TO THE OWNER AND GENERAL CONTRACTOR FOR REVIEW PRIOR TO PLACING ORDER. ANY VARIANCE SHALL BE RESOLVED BY THE OWNER/GENERAL CONTRACTOR.   | D15 0 SHOWER/BATH<br>D16 0 W.C./BATH   | 1 30"X80" POCKET<br>1 30"X80" POCKET  | HOLLOW POCKET DOOR<br>HOLLOW POCKET DOOR  | WARE SBO O   | UT STONE  | 3-0 1 - 0 - 0 - 0 - 0 - 0 - 0 - 0 - 0 - 0         | CHELSEA, Qc.  |
| 2- ALL WINDOWS ARE TO BE 100% WHITE PVC AND ARE TO MEET THE MINIMUM "U" VALUE SPECIFIED IN NATIONAL BUILDING CODE SECTION OR ARE TO BE BETTER.  | D17 0 HALL/STORAGE   | 1 30"X80" HINGED  | HOLLOW DOOR, 1 PAIR CF HINGES, PASS<br>STRIKE   | AGE SET WITH LATCH SBO   | CONDUIT HAVING A  |   | DRAWING TITLE   |
|   | D18 0 BEDRM #4/HALL  | 1 30"X80" HINGED  | HOLLOW DOOR, 1 PAIR OF HINGES, PRI<br>LATCH STRIKE<br>HOLLOW DOOR, 1 PAIR OF HINGES, PASS     | SBO IN   | MINIMUM OF 4" DIAME<br>(PERFORATED SECTIO   | TER / _   | GENERAL NOTES   |
|   | D19 0 BEDRM #4/W.I.C. BEDRM #4<br>D20 0 W.I.C. BEDRM #3/BEDRM #3                                       |   | STRIKE<br>HOLLOW DOOR, 1 PAIR (F HINGES, PASS   | SBO IN   | PERMEABLE LAYER OF  | F CLEAN 3/4" GRANULAR                             | PROJECT DIRECTOR FILE NAME  |
|   | D21 0 HALL/BEDRM #3  | 1 30"X80" HINGED  | HOLLOW DOOR, 2 PAIRS OF HINGES  |  |   | S OF 12" MIN. AROUND                              | FRANK MURRAY N/A  |
|   | D22 0 HALL/FAMILY<br>D23 0   | 1 (2)30"X80" DOUBLE HIN<br>1 36"X80" HINGED   | GED LATCH STRIKE<br>HOLLOW DOOR, 1 PAIR (F HINGES, PASS                                       | 580 0  |   | N PIPE DETAIL                                     | AL-20-54 Nov. 2020  |
|   |  | ROUGH OPENING. REFER TO MANUFACTUR  | STRIKE<br>ER'S SCHEDULE FOR EXACT DOOR FRAME I  | DIMENSIONS AND ROUGH OPENING   |   |   | SCALE DRAWING NUMBER  |
|   | SBO = STYLE BY OTHERS  |   |   |  |   |   | As Shown A2 of 13   |

| P.S. | STEEL ANGLE | S SHALL HAVE | 6" MIN. BEAR | ING AT BOTH | END |
|------|-------------|--------------|--------------|-------------|-----|
|      |             |              |              |             |     |


| W#  | FLR | ROOM NAME          | QTY | DIMENSIONS<br>W X H | DESCRIPTION                              | COMMENTS                       | AREA<br>(SQFT) |
|-----|-----|--------------------|-----|---------------------|--|--------------------------------|----------------|
| W01 | 0   | BEDRM #4           | 1   | 56"X30"DC           | DOUBLE<br>CASEMENT-LHL<br>TO MEET EGRESS |                                | 11.67          |
| W02 | 0   | BEDRM #3           | 1   | 56"X30"DC           | DOUBLE<br>CASEMENT-LHL<br>TO MEET EGRESS |                                | 11.67          |
| W03 | 0   | FAMILY             | 2   | 56"X30"DC           | DOUBLE<br>CASEMENT-LHL                   |                                | 11.67          |
| W04 | 1   | ENTRY/<br>VERANDA  | 1   | 30"X36"             | FIXED GLASS-AT                           |                                | 5.88           |
| W05 | 1   | LIVING/<br>VERANDA | 1   | 30"X63"SC           | SINGLE<br>CASEMENT-HR                    | LITES IN BETWEEN<br>GLASS PANE | 13.12          |
| W06 | 1   | LIVING             | 2   | 30"X63"SC           | SINGLE<br>CASEMENT-HL                    | LITES IN BETWEEN<br>GLASS PANE | 13.12          |
| W07 | 1   | DINING             | 1   | 60"X63"DC           | DOUBLE<br>CASEMENT-LHL                   | LITES IN BETWEEN<br>GLASS PANE | 26.25          |
| W08 | 1   | KITCHEN            | 1   | 30"X40"SC           | SINGLE<br>CASEMENT-HL                    | LITES IN BETWEEN<br>GLASS PANE | 8.33           |
| W09 | 1   | MASTER BDRM        | 1   | 60"X63"DC           | DOUBLE<br>CASEMENT-LHL                   | LITES IN BETWEEN<br>GLASS PANE | 26.25          |
| W10 | 1   | BATH               | 1   | 60"X48"DC           | DOUBLE<br>CASEMENT-LHL                   | LITES IN BETWEEN<br>GLASS PANE | 20.0           |
| W11 | 1   | BEDRM #2           | 1   | 60"X60"DC           | DOUBLE<br>CASEMENT-LHL                   | LITES IN BETWEEN<br>GLASS PANE | 25.0           |

| EMENT NOTES  | FOUND                             | ATION NO                                 | DTES FL                     | OOR PLAN NOTES   | ABBREVIATION   | S LEGEND:   | N.C.   |  |
|--|-----------------------------------|--|-----------------------------|--|--|---|--|--|
| WEEPING TILE IN A SOX TO   | SOIL BEAF                         | RING                                     |                             | > ALL EXTERIOR WALLS ARE IN 2x6  | A.A. ATTIC ACCESS<br>ABV ABOVE   | A DETAIL OR SECTION NUMBER  | N R  |  |
| NSTALLED AT THE PERIMETER<br>TG. AND COVERED/W 6" OF                           |                                   | AND PADS MUS                             | NS W                        | STUDS @ 16"c/c AND ALL INTERIOR<br>VALLS ARE IN 2x4 STUDS @ 10"cdc           | A.B. ANCHOR BOLT<br>B.F. BI FOLD   | Electric Smoke & Carbon   |  |  |
| AR CRUSHRUN STONE  | SPECIFIED ON                      | N UNDISTURBED                            | SOIL                        | INLESS OTHERWISE SPECIFED  | BLK. BLOCK<br>BLW. BELOW   | Monoxide Detector/w Battery<br>Back-up c/w Signaling Device                         |  | MAISONS  |
| L VAPOR BARRIER SHALL BE<br>ALLED UNDER BASEMENT                               | CAPACITY. AL                      | PSF (75 KPa) BE                          | S                           | > NAT. GAS FIREPLACE MANUE SPECS<br>SHALLL BE LEFT ON SITE FOR               | B/W BOTH WAYS<br>B.P. BEAM POCKET 3 1/2"   | when in Bedoom, all<br>Interconnected with Each                                     | WINDOW   |  |
| B EXCEPT IF UNDER SLAB IS<br>JLATED WITH RIGID INSUL.                          |                                   | ST BE CONFIRME<br>CAL ENGINEER.          |                             | NSPECTOR. (IF FIREPLACE IS INSTALLED)<br>> INSULATE AND CONTINUE VAPOUR      | CATH. CATHEDRAL<br>CLG. CEILING<br>COL. COLUMN   | Other   | OPENING  |  |
|  | POURED                            | CONCRETE                                 | В                           | BARRIER WHERE INTERIOR WALLS   | CONC. CONCRETE<br>CSMT. CASEMENT   | Provide Mechanical<br>Exhaust to Outside  | 8"   | TIOMEO   |
| WEEN WOOD & CONCRETE<br>ESS P/T WOOD IS USED.                                  | A> CONCRETE W                     | ORK SHALL CONFO                          | RM TO                       | IEETS WITH EXTERIOR WALLS<br>> PROVIDE CAULKING AT ALL EXTERIOR              | C/C CENTER<br>C/W COMPLETE WITH<br>DBL DOUBLE  | Fan - Exhaust to Outside  |  | 710-1180 Chemin d'Aylmer<br>Gatineau, Qc., J9H 0G5   |
| RIM JSTS SHALL BE<br>ALLED OVER FOUNDATION                                     | AGGREGATE                         | SIZE OF 3/4"(20mm)                       | AND W                       | VALL FRAMING WHERE FRAM  | DECO. DECORATIVE<br>DIA DIAMETER   |   |  | OFFICE: (Qc) 1-819-503-6820<br>(Qn) 1-613-789-0220   |
| L PARALLEL TO FLOOR JSTS   | - 20 Mpa (2900 PS                 |  |                             | > ALL HOSE BIB SHALL HAVE A BACK   | DISP. DISPOSAL<br>DJ DOUBLE JOISTS<br>DRJ DOUBLE RIM JOISTS                            | 2x6 Mechanical Wall   | 4  | CEL: 819-743-9220  |
| WATER TANK SHALL BE<br>JRED TO HOUSE STRUCTURE                                 | · ·                               | SI) GARAGE & EXT. S                      | SLAB                        |  | DR. DOOR<br>DW DISH WASHER   | CARRY ALL POINT LOAD DOWN<br>TO FOUNDATION  |  | WWW.PARAGONHOMES.CA  |
| ING & MECHANICAL VENTILATION   |                                   | TE EXPOSED TO CY<br>DEFROST, ENTRAIN     | ED AIR F                    | > ALL TOILET SHALL BE 6 LITRES PER<br>FLUSH MAXIMUM. ADD BLOCKING IN         | E.E. EACH END<br>ELEC. ELECTRICAL  | WOOD POST/STEEL COL. LEGEND   | MEMBRANE TO BE INTALLED  |  |
| EM SHALL BE INSTALLED AS PER<br>E AND MANUFACTURER'S SPECS                     | MUST BE BET<br>PER CAN3-A2        | TWEEN 4.5 to 7% AN<br>266.1 M78          | В                           | NALL NEAR TOILET, SHOWER AND<br>BATH TUB FOR FUTUR GRAE BAR AS               | ELEV. ELEVATION<br>EXT. EXTERIOR<br>EXIST. EXISTING                                    | When NOT SPECIFIED, Standard  | AFTER AIR BARRIER WRAP<br>AND PRIOR TO INSTALL   | CONSTRUCTION PROJECT MANAGEMENT  |
| L BE LEFT ON SITE.<br>. Sec. 9.9.10.1.(1) EXIT WINDOW                          | C> CONCRETE IS                    |  | 11                          | PER BARRIER FREE DESIGN REQUIRMES  | F.G. FINISH GRADE<br>F.R. FIRE RATED   | <ul> <li>Support (BOTH END) of Header<br/>Above Openings in Load Bearing</li> </ul> | WINDOW   | BY PARAGON HOMES   |
| EMENT) Shall be Openable from the<br>Without the Use of Tools and Provides     | D> FOR NORMAL                     | STRUCTURAL CON                           | CRETE                       | SHALL NOT EXCEED 49%%D. (MOONG VALVE)  | FIN. FINISHED<br>FL. FLOOR   | Stud Wall is 1 JACK and 1 KING.<br>P1 = "x "x 1/4" HSS POST                         | GD2 WINDOW SILL  |  |
| dividual Unobstructed Open Portion<br>g a Minimum Area of 0.35m2 with no       | IF FOR ANY R                      | B PERIOD IS 28 DAYS<br>REASON, THE CONTR | RACTOR                      | > ALL DOORS GIVING DIRECT ACCESS TO<br>OUSE FROM OUTSIDE SHALL BE            | FW. FOUNDATION WALL<br>G.T. GIRDER TRUSS   |   | A2 DAMPROOFING   |  |
| nsions Less than 380mm.  | OR APPLY AN                       | ISMANTLE THE FOR                         |                             | QUIPPED WITH DEADBOLT LOCK   | GA. GAUGE<br>GALV. GALVANIZED<br>GL. GLASS   | P1a = REDJACK LIGHT DUTY  | $\sim$   | CUSTOM ENGINEERED HOME<br>PACKAGES-KIT BY PARAGON HOMES                                      |
| the Window Opens into a Window Well<br>arance of 22" (550mm) shall be provided |                                   | RING PERIOD IS OVE<br>T A WRITTEN CONSI  | R S                         | O RESIST SPREADING BY FORCE  | GS. GIRDER SUPPORT<br>HOT. HEIGHT  | TYPE 2 JACKPOST<br>T2JPLD   |  |  |
| nt of Window.  |                                   | JCTURAL ENGINEEF<br>OR DEAD LOAD OT      | K.                          | > DOOR GIVING ACCESS FROM GARAGE   | HORIZ HORIZONTAL<br>HR HOUR  | P1b = BLACKJACK MEDIUM DUTY<br>TYPE 2 JACKPOST                                      | *  | LEGEND   |
|  | THAN THE OV                       | WN WEIGHT OF THE                         | T                           | O HOUSE SHALL BE METAL INSUL<br>COMPLETE/W SELF CLOSER, DEADBOLT             | H.E. HOOD EXHAUST  | T2JPMD  | 2:0" W01,W02,W03 12:0"<br>Window 1   |  |
|  | APPLIED DUR                       | RING CURING PERIO                        | D. A                        | ND WEATHERSTRIP  | INT. INTERIOR<br>JST JOISTS<br>JH JOIST HANGER   | P1c = REDJACK HEAVY DUTY<br>TYPE 2 JACKPOST   |  |  |
| ORTED AT   | 24H. WRITTEI                      | NOTICE BEFORE                            | POURING                     | 0> ALL OPENING IN RAILING & GUARDS<br>SHALL BE DESIGNED TO PREVENT THE       | KIT. KITCHEN   | T2JPHD<br>P2 = (2)2x6 STUD POST (1 Jack +   | Example of the second s |  |
|  |                                   | VHEN ENG. SEAL IS<br>S STEEL MUST MEET   | ON PLAN                     | PASSAGE OF A 4" DIA. SPHERE AND<br>PREVENT CLIMBING.                         | LG. LONG<br>LIN. LINEN   | 1 King NAILED TOGETHER)   | i Foundation (2)15M Rebar (Typ.)   |  |
|  | WELDED WIR                        | ND REINFORCING<br>RE FABRIC MUST ME      | ET N11                      | 1> DIVIDING WALL BETWEEN GARAGE  | LT. LIGHT<br>LVL LAMINATED VENEER LUMBE<br>M.C. MEDICINE CABINET                       | R P2a = (2)2x6 STUD POST<br>(2 Kings NAILED TOGETHER)                               | 1 (2)15M Rebar (Typ.)  |  |
|  | G30.3 AND IS                      | SUPPLIED IN SHEET<br>MUST BE 400 Mpa (60 | TS AI                       | ND HOUSE SHALL BE COVERED<br>VITH 1/2" DRYWALL ON BOTH SIDE                  | MECH. MECHANICAL<br>M.R.H. MEAN ROOF HEIGHT  | P3 = (3)2x6 STUD POST (2 Jack +   |  |  |
| (2)15M REBARS CONTINUOUS<br>AT TOP C/W 15M "L" BARS                            | CLEAN OF AN                       | IY DIRT, AND LAID                        | 0                           | OF WALL AND DOUBLE TAPE JOINTS   | M.T. METAL THRESHOLD<br>MAX. MAXIMUM<br>MFR. MANUFACTURER                              | 1 King NAILED TOGETHER)<br>P3a = (3)2x6 STUD POST                                   | Footng   |  |
| (24"x24") IN CORNERS   | REBARS C                          | CONC. COVE                               | -в II                       | 2> WALL STUDS SHALL BE CONTINUOUS  | M/W MICROWAVE<br>MIN. MINIMUM  | (3 Kings NAILED TOGETHER)<br>P4 = (4)2x6 STUD POST (3 Jack +                        |  |  |
|  | I> MIN. CLEAR CC<br>A) CAST AGAIN | OVER SHALL BE:<br>ST AND PERMANEN        |                             | FOR THE FULL STOREY HEIGHT EXCEPT  | MTL METAL<br>O.H.D. OVER HEAD DOOR   | 1 King NAILED TOGETHER)   | GD3 EOUNDATION WALL REINFORCEM'T   |  |
|  | É EXPOSED T                       |  | 5mm (3")<br>ER: N13         | 3> INDIVIDUAL MEMBER OF BUILT UP   | PL PLATE<br>PL.F. POUNDS PER LINEAR FOOT   | P4a = (4)2x6 STUD POST<br>(4 Kings NAILED TOGETHER)                                 | A2 AT WINDOW: W01 W02 & W03<br>SCALE: 3/16"=1'-0"  |  |
|  | - 20M TO 55                       |  | 0mm (2") L L V              | INTELS SHALL BE FASTENED TOGETHER<br>WITH A MIN. OF 3 1/2" NAILS IN A DOUBLE | P.S.F. POUNDS PER SQUARE FOO<br>P.S.I. POUNDS PER SQUARE INCH<br>P.T. PRESSURE TREATED | P5 = 4x4 WOOD POST P/T  |  | FOR ALL TECHNICAL ISSUE OR QUESTIONS, CONTACT  |
|  | AND SM                            | ALLER 40mm                               | (1.1/2")                    | ROW SPACED @ 17 3/4" O.C. MAX<br>4> FRAMER TO REFER TO FLOOR JOIST           | PART'N, PARTITION<br>PKT POCKET<br>PLYWD, PLYWDOD                                      | P6 = 6x6 WOOD POST P/T<br>P7 = 5 1/4" x 5 1/4" PSL                                  |  | PARAGON HOMES BEFORE CONTINUING THE WORK.  |
| – (2)15M REBARS CONTINUOUS   | - FOR 15M AND                     | OF REBARS SHALL<br>SMALLER = 500mm       | (20") N                     | MANUFACTURER'S PLAN FOR DETAILS  | R.O. ROUGH OPENING   | TIMBER POST   |  | THE CONTRACTOR WILL BE LIABLE TO CONFIRM ALL<br>DIMENSIONS AND CONDITIONS AFFECTING THE WORK |
| AT BOT. C/W 15M "L" BARS<br>(24"x24") IN CORNERS                               |                                   | BIGGER = 600mm (2<br>OVIDE CORNER REE    | ARS N1                      | F WOOD I JOISTS ARE TO BE USED<br>5> RANGE/COOKTOP HOOD & DRYER              | S.A. STEEL ANGLE<br>S.B. SOLDIER BRICK   | If Header is NOT Tight Under Top<br>Plates, Solid Blocking to Match                 |  | SITE AND WILL BE SOLELY RESPONSIBLE FOR THE<br>ACCURACY OF MEASUREMENTS AND OBSERVATIONS.    |
| 2" (R10) RIGID INSUL. @  | OF 600mm x 6<br>SPACED SAM        | 600mm (24" x 24")<br>IE AS WALL REINFOF  |                             | SHALL BE EQUIPPED WITH EXHAUST<br>DUCT LEADING TO OUTSIDE                    | S.C. SOLID CORE<br>S.G.D. SLIDING GLASS DOOR<br>SF SQUARE FOOT                         | Support shall be installed at Ends.   |  | THE CONTRACTOR WILL REPORT ANY ERRORS.   |
| SLAB PERIMETER   | STEEL ANGL                        | LES FOR MAS                              | ONRY VENEE                  | R (Table 9.20.5.2.B)   | SH SINGLE HUNG<br>SIL SIDELIGHT  | HEADER LEGEND:  |  | OMISSIONS OR DEFECT TO PARAGON HOMES BEFORE<br>THE COMMENCEMENT OF WORK.                     |
| (2)15M REBARS CONTI.   |                                   | AR SPAN                                  |                             | NGLES FOR 4" BRICK & STONE   | S.S.T. SIMPSON STRONG TIES<br>ST. STIRRUPS   | All Header To Be (2)2x10 with P2  |  | CHECK EXISTING CONDITIONS ON SITE AND ADJUST AS  |
| CONTI. IN FTG.   | L1 <u>≤</u> 2.30m<br>L2 2.48m     | <u>&lt;7'-6" (90")</u><br>8'-0" (96")    | L 89 x 89 x<br>L 102 x 89 x |  | STL STEEL<br>SW SWTCH<br>SWC SOLID WOOD CORE   | UNLESS OTHERWISE NOTED.<br>H1 = (2)2x12 H4 = (2)2x10 H7 = (2)2x8                    |  | NECESSARY.   |
| INFO. SEE FOUNDATION PLAN  | L3 3.08m                          | 10'-0" (120")                            | L 127 x 89 x                |  | TH THECK<br>T.O.FD. TOP OF FOUNDATION  | H2 =(3)2x12 H5 =(3)2x10 H8 =(3)2x8<br>H3 =(4)2x12 H6 =(4)2x10 H9 =(4)2x8            |  | ALL WORK TO BE PERFORMED,<br>- ACCORDING TO ESTABLISH AND STANDARDS AS                       |
| ORCEMENT   | L4 3.24m<br>L5 3.33m              | 10'-7" (127")<br>10'-11" (131")          | L 127 x 89 x                |  | T.O.FTG TOP OF FOOTING<br>T.O.PL. TOP OF WOOD PLATE<br>TJ TRIPLE JOISTS                | H10=(2)2x6 H11=(3)2x6 H12=(4)2x6  |  | REQUIRED BY CODES.<br>- BY RULES OF THE ART.   |
| FED AT TOP (Ex: Wall   | L6 3.54m                          | 11'-7" (139")                            | L 152 x 89 >                | x 11 L 6" x 3 1/2" x 7/16"   | TYP. TYPICAL<br>US UNDERSIDE   | -1 1  |  | - IF THERE IS A PLACE IN ACCORDANCE WITH THE<br>RECOMMENDATIONS OF THE MANUFACTURERS OF THE  |
| und.) See Other Details  | L7 3.77m<br>L8 3.82m              | 12'-4" (148")<br>12'-6" (150")           | L 152 x 89 x                |  | VERT. VERTICAL   | 1 1   |  | MATERIAL OR EQUIPMENT.   |
|  | L9 3.99m                          | 13'-1" (157")                            | L 178 x 102                 | 2 x 11 L 7" x 4" x 7/16"   | W/ WTH<br>WC WATER CLOSET<br>WD. WOOD  |   |  | QUEBEC CONTRACTORS WILL BE HELD LIABLE TO THEIR<br>SPECIFIC SUB-TRADES RESPONSIBILITIES WHEN |
| CALE: N.T.S. GD1   | L10 4.25m                         | 13'-11" (167")                           | L 178 x 102                 | 2 x 13 L 7" x 4" x 1/2"  |  |   |  | BUILDING THIS CUSTOM HOME. THE SAME SHALL BE<br>APPLICABLE FOR ONTARIO SUB-TRADES.           |
|  |                                   |  |                             |  |  |   |  | DO NOT SCALE THE DRAWINGS.   |
|  |                                   |  | DOOR SCH                    | HEDULE   |  | 01000   |  | 07   |
| D# FLR ROOM NAME   | QT                                | DIMENSION                                | TYPE                        | COMMENTS<br>MTL INSUL. C/W 3/4 GLASS REY IN R                                | DESCRIPTION  | SIDE  |  | 06   |
| D01 1 ENTRY/VERANDA  | 1                                 | 68 7/8" X 95"<br>(36"X80")               | MULLED UNIT                 | LATCHSTRIKE, 1 1/2<br>WEATHERSTRIP, (2) SIDE                                 | ES. DOOR SILL & SBO  |   |  | 04   |
| D02 1 GARAGE   | 1                                 | 32"X80"                                  | HINGED                      | MTL INSUL. C/W 3/4 G<br>LATCHSTRIKE, 1 1/2                                   | NOB & DEADBOLT/W   | IN .  |  | 03<br>12/23/2020 Issued to Struct. Eng. for Review 02  |
|  | '                                 |  | -                           | MTL INSUL OVERHEAD COOR CW GARA  |  |   |  | 7/14/2020 First Preliminary Design Stage 01 DESCRIPTION REV.                                 |
| D03 1 GARAGE<br>D04 1 CLOSET/ENTRY   | 1                                 | 9'X8' OHD<br>60"X80"                     | GARAGE<br>SLIDER            | KIT  | SBO  | IN  |  | m/d/y  |
| D05 1 ENTRY/GARAGE   | 1                                 |  | HINGED                      | MTL INSUL. C/W KEY IN K<br>1 1/2 PAIR OF HINGES, DC                          |  | IN  |  | AL.  |
| D06 1 DINING/COVERED DECK  | 1                                 | 70 1/2" X 82 1/8"                        |                             | PATIO DOOR<br>HOLLOW DOOR, 1 PAIR (F HINGES, PASSA                           | ISBO   | 11  |  | F.M  |
| D07 1 HALL/W.I.P.  | 1                                 |  | HINGED                      | STRIKE<br>HOLLOW DOOR, 1 PAIR  | 000  | TOP OF THE RADON  |  |  |
| D08 1 LNDRY/HALL   | 1                                 |  | HINGED                      | LATCH STRIKE<br>HOLLOW DOOR, 1 PAIR OF HINGES, PRA                           | 000  | CONDUIT SEALED AN   | MI M_DEDEDED ATEL  |  |
| D09 1 BEDRM #2/HALL  | 1                                 |  | HINGED                      | LATCH STRIKE<br>HOLLOW DOOR, 1 PAIR CENTISES PASSA                           | 500  | CLEARLY LABELED   | CENTER OF THE  | MODEL BY: CLIENT   |
| D10 1 CLOSET BEDRM #2/BEDRI  | M #2 1                            |  | HINGED                      | STRIKE<br>HOLLOW DOOR, 1 PAIR OF HINGES, PRA                                 | 100  | OUT SEALED  | CEMENT SLAB  |  |
| D11 1 BATH/HALL  | 1                                 |  | HINGED                      | HOLLOW DOOR, 1 PAIR OF HINGES, PRI<br>HOLLOW DOOR, 1 PAIR OF HINGES, PRI     | www.   |   | BASEMENT SLAB  | PROJECT ADDRESS<br>PROPOSED RESIDENCE  |
| D12 1 MASTER BDRM/HALL<br>D13 1 MASTER BDRM/CLOSET M                           |                                   |  | HINGED<br>SLIDER            |  | 580  | N C   |  | AILEEN & CLINT SMYTH   |
| D14 0 BATH/HALL  | 1                                 |  | HINGED                      | HOLLOW DOOR, 1 PAIR OF HINGES, PRIMILATCH STRIKE                             | VACY LOCKSET WITH SBO  | N GRANULAF  |  | Chemin SUSAN, LOT #2634998   |
| D15 0 SHOWER/BATH<br>D16 0 W.C./BATH   | 1                                 | 30"X80"                                  | POCKET<br>POCKET            | HOLLOW POCKET DOOR   | WARE SBO   | STONE STONE   | 0.00 1.0 1.00 1.00 1.00 1.00 0.00 1.00 0.00  | CHELSEA, Qc.   |
| D17 0 HALL/STORAGE   | 1                                 |  | HINGED                      | HOLLOW DOOR, 1 PAIR C  | AGE SET WITH LATCH SBO   | IN La standing  | to the transferred to the transf | DRAWING TITLE  |
| D18 0 BEDRM #4/HALL  | 1                                 | 30"X80"                                  | HINGED                      | HOLLOW DOOR, 1 PAIR OF HINGES, PRIN<br>LATCH STRIKE                          | VACY LOCKSET WITH SBO  | IN CONDUIT HAVING A<br>MINIMUM OF 4" DIAME  | MIN. MIN. T  | GENERAL NOTES  |
| D19 0 BEDRM #4/W.I.C. BEDRM #  | #4 1                              | 24"X80"                                  | HINGED                      | HOLLOW DOOR, 1 PAIR (F HINGES, PASS)<br>STRIKE                               | AGE SET WITH LATCH SBO   | (PERFORATED SECTIO  |  |  |
| D20 0 W.I.C. BEDRM #3/BEDRM #  |                                   | 24"X80"                                  | HINGED                      | HOLLOW DOOR, 1 PAIR OF HINGES, PASS/<br>STRIKE                               | AGE SET WITH LATCH SBO   |   | F CLEAN 3/4" GRANULAR  | PROJECT DIRECTOR FILE NAME   |
| D21 0 HALL/BEDRM #3  | 1                                 | 30"X80"                                  | HINGED                      | HOLLOW DOOR, 2 PAIRS OF HINGES I   | DASSAGE CET INITI  | OUT COARSE ON A RADIU   | IS OF 12" MIN. AROUND/   | FRANK MURRAY N/A   |
| D22 0 HALL/FAMILY  | 1                                 |  | DOUBLE HINGED               | HOLLOW DOOR, 2 PAIRS<br>LATCH STRIKE<br>HOLLOW DOOR, 1 PAIR CENTRES PASS     | 580  | 100   |  | PROJECT NUMBER DATE  |
| D23 0  | 1                                 |  | HINGED                      | ISTRIKE  | 000  | 10 0000 0000  |  | AL-20-54 Nov. 2020   |
| P.S.: ALL DIMENSIONS ARE <b>NO</b><br>SBO = STYLE BY OTHERS                    | T ROUGH OPENIN                    | NG. REFER TO MA                          | NUFACTURER'S                | SCHEDULE FOR EXACT DOOR FRAME D  | DIMENSIONS AND ROUGH OPENIN  | GS. A2 SCALE: 3/4   | e = 1 - 0  | SCALE DRAWING NUMBER   |
|  |                                   |  |                             |  |  |   |  | As Shown A2 of 13  |
|  |                                   |  |                             |  |  |   |  |  |




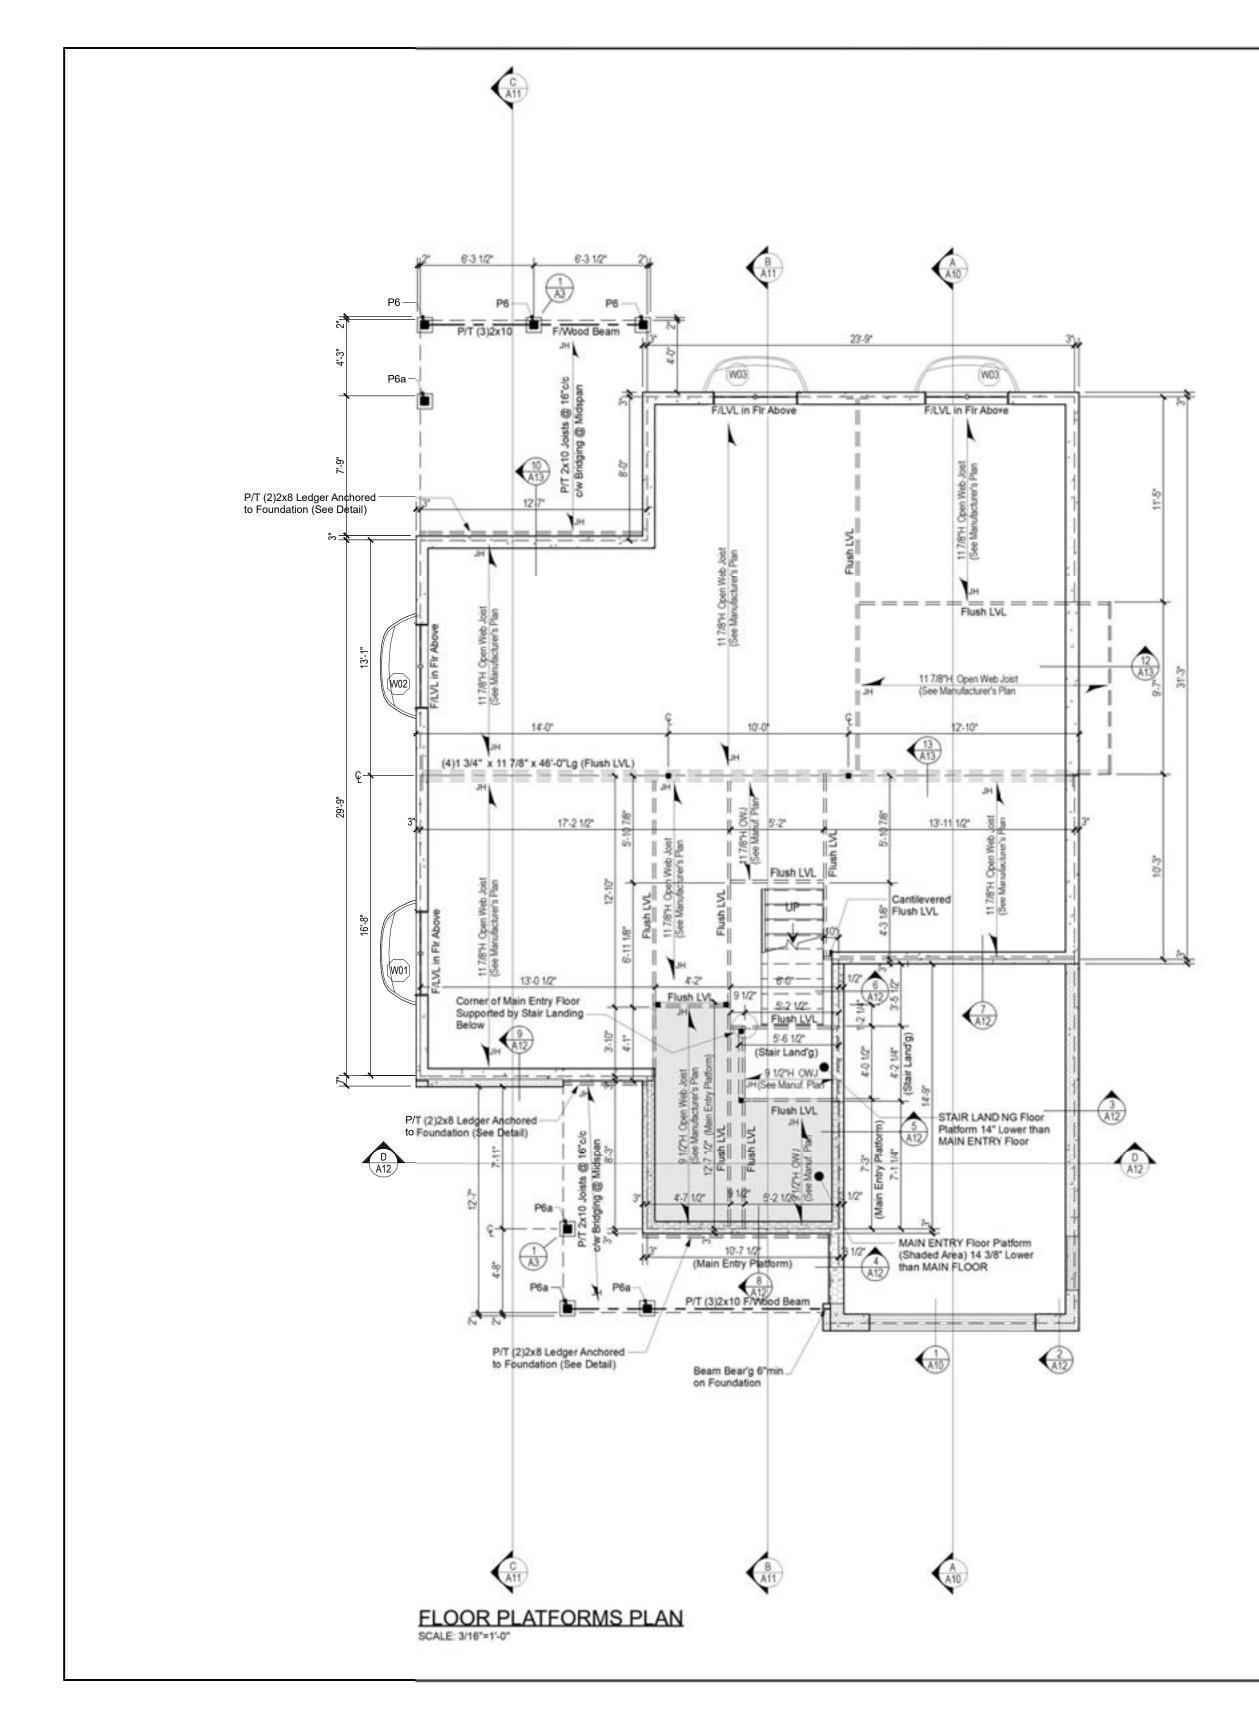



| SEE FOUNDATION & BASM'T<br>RELATED NOTES ON A2  |   |
|---|---|
| LEGEND:<br>A DETAIL OR SECTION NUMBER<br>SHEET NO. WHERE TO FIND IT<br>Electric Smoke & Carbon<br>Monoxide Detector/w Battery<br>Back-up c/w Signaling Device<br>when in Bedoom, all<br>Interconnected with Each<br>Other<br>Provide Mechanical<br>Exhaust to Outside<br>Bathroom Fan | MAISONS<br>PARAGON<br>HOMES<br>710-1180 Chemin d'Aylmer<br>Gatineau, Qc., J9H 0G5<br>OFFICE: (Qc) 1-819-503-6820<br>(On) 1-613-789-0220<br>CEL: 819-743-9220<br>WWW PARAGONHOMES.CA   |
| See WINDOW Schedule on A2     D#) See DOOR Schedule on A2   | CONSTRUCTION PROJECT MANAGEMENT<br>BY PARAGON HOMES   |
| CARRY ALL POINT LOAD DOWN<br>TO FOOTING & FOUNDATION  | CUSTOM ENGINEERED HOME<br>PACKAGES-KIT BY PARAGON HOMES   |
|   |   |
|   | NOTEB<br>FOR ALL TECHNICAL ISSUE OR QUESTIONS, CONTACT<br>PARAGON HOMES BEFORE CONTINUING THE WORK.<br>THE CONTRACTOR WILL BE LIABLE TO CONFIRM ALL<br>DIMENSIONS AND CONDITIONS AFFECTING THE WORK<br>SITE AND WILL BE SOLELY RESPONSIBLE FOR THE<br>ACCURACY OF MEASUREMENTS AND OBSERVATIONS.<br>THE CONTRACTOR WILL REPORT ANY ERRORS,<br>OMISSIONS OR DEFECT TO PARAGON HOMES BEFORE<br>THE COMMENCEMENT OF WORK.<br>CHECK EXISTING CONDITIONS ON SITE AND ADJUST AS<br>NECESSARY.<br>ALL WORK TO BE PERFORMED,<br>- ACCORDING TO ESTABLISH AND STANDARDS AS<br>REQUIRED BY CODES. |
|   | BY RULES OF THE ART.     IF THERE IS A PLACE IN ACCORDANCE WITH THE<br>RECOMMENDATIONS OF THE MANUFACTURERS OF THE<br>MATERIAL OR EQUIPMENT.<br>QUEBEC CONTRACTORS WILL BE HELD LIABLE TO THEIR<br>SPECIFIC SUB-TRADES RESPONSIBILITIES WHEN<br>BUILDING THIS CUSTOM HOME. THE SAME SHALL BE  |
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|   | A.L.<br>F.M   |
|   | MODEL BY: CLIENT  PROJECT ADDRESS  PROPOSED RESIDENCE  All EEN & CLINT SMYTH  |
|   | AILEEN & CLINT SMYTH<br>Chemin SUSAN, LOT #2634998<br>CHELSEA, Qc.<br>DRAWING TITLE   |
|   |   |

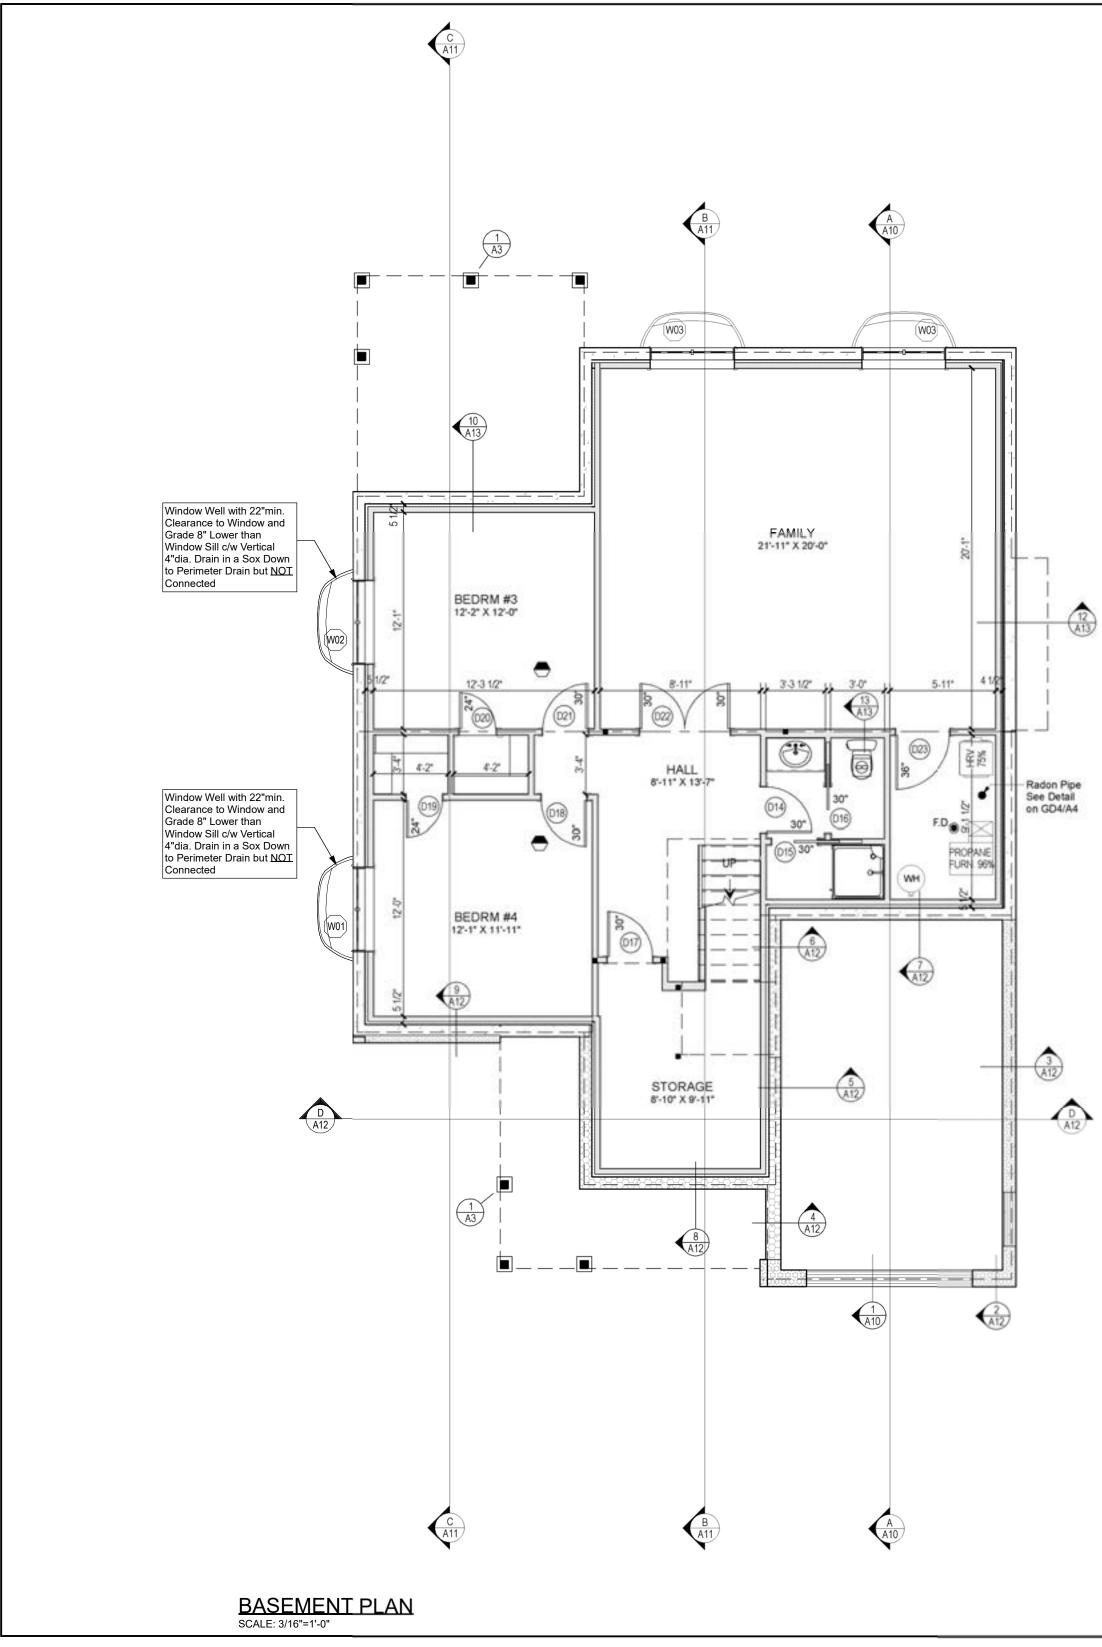

| LEGEND:   | MAISONS  |
|---|--|
| A DETAIL OR SECTION NUMBER<br>A SHEET NO. WHERE TO FIND IT  | PARAGON  |
| Electric Smoke & Carbon                                     |  |
| Monoxide Detector/w Battery<br>Back-up c/w Signaling Device | HOMES  |
| when in Bedoom, all   |  |
| Interconnected with Each<br>Other                           | 710-1180 Chemin d'Aylmer<br>Gatineau, Qc., J9H 0G5   |
|   | OFFICE: (Qc) 1-819-503-6820<br>(On) 1-613-789-0220   |
| Provide Mechanical<br>Exhaust to Outside                    | CEL: 819-743-9220  |
| Seven Dearman and Provide States                            | WWW.PARAGONHOMES.CA  |
| Bathroom Fan  |  |
| See WINDOW Schedule on A2                                   | CONSTRUCTION PROJECT MANAGEMEN   |
|   | BY PARAGON HOMES   |
| See DOOR Schedule on A2                                     |  |
| RRY ALL POINT LOAD DOWN                                     |  |
| DOTING & FOUNDATION   | CUSTOM ENGINEERED HOME<br>PACKAGES-KIT BY PARAGON HOMES  |
| 2 x 6 @ 16"c/c Interior Wall                                | PACKAGES-KIT BT PARAGON HOMES  |
| -   | LEGEND   |
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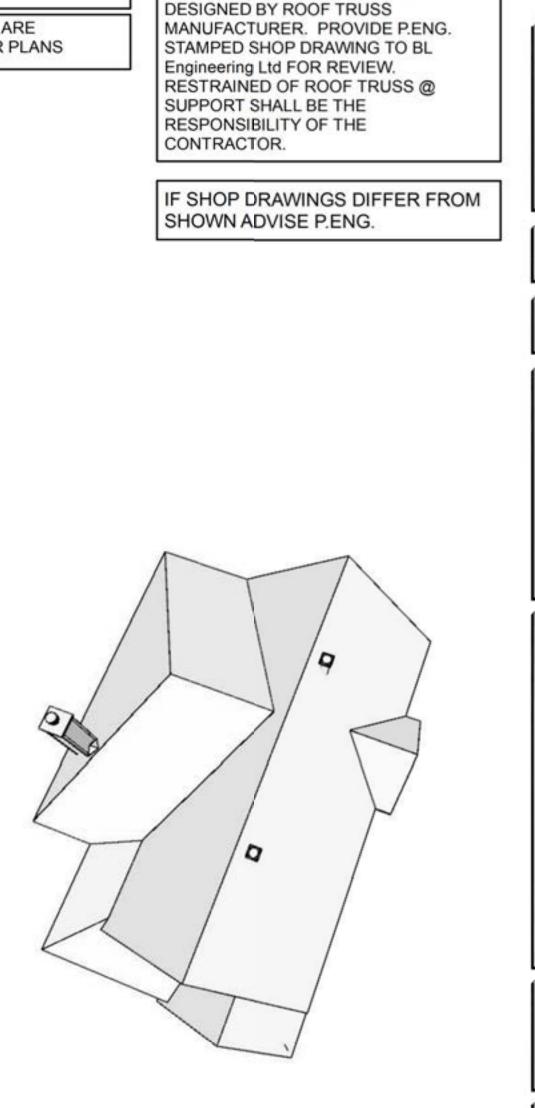
CARRY ALL POINT LOAD DOWN TO FOUNDATION

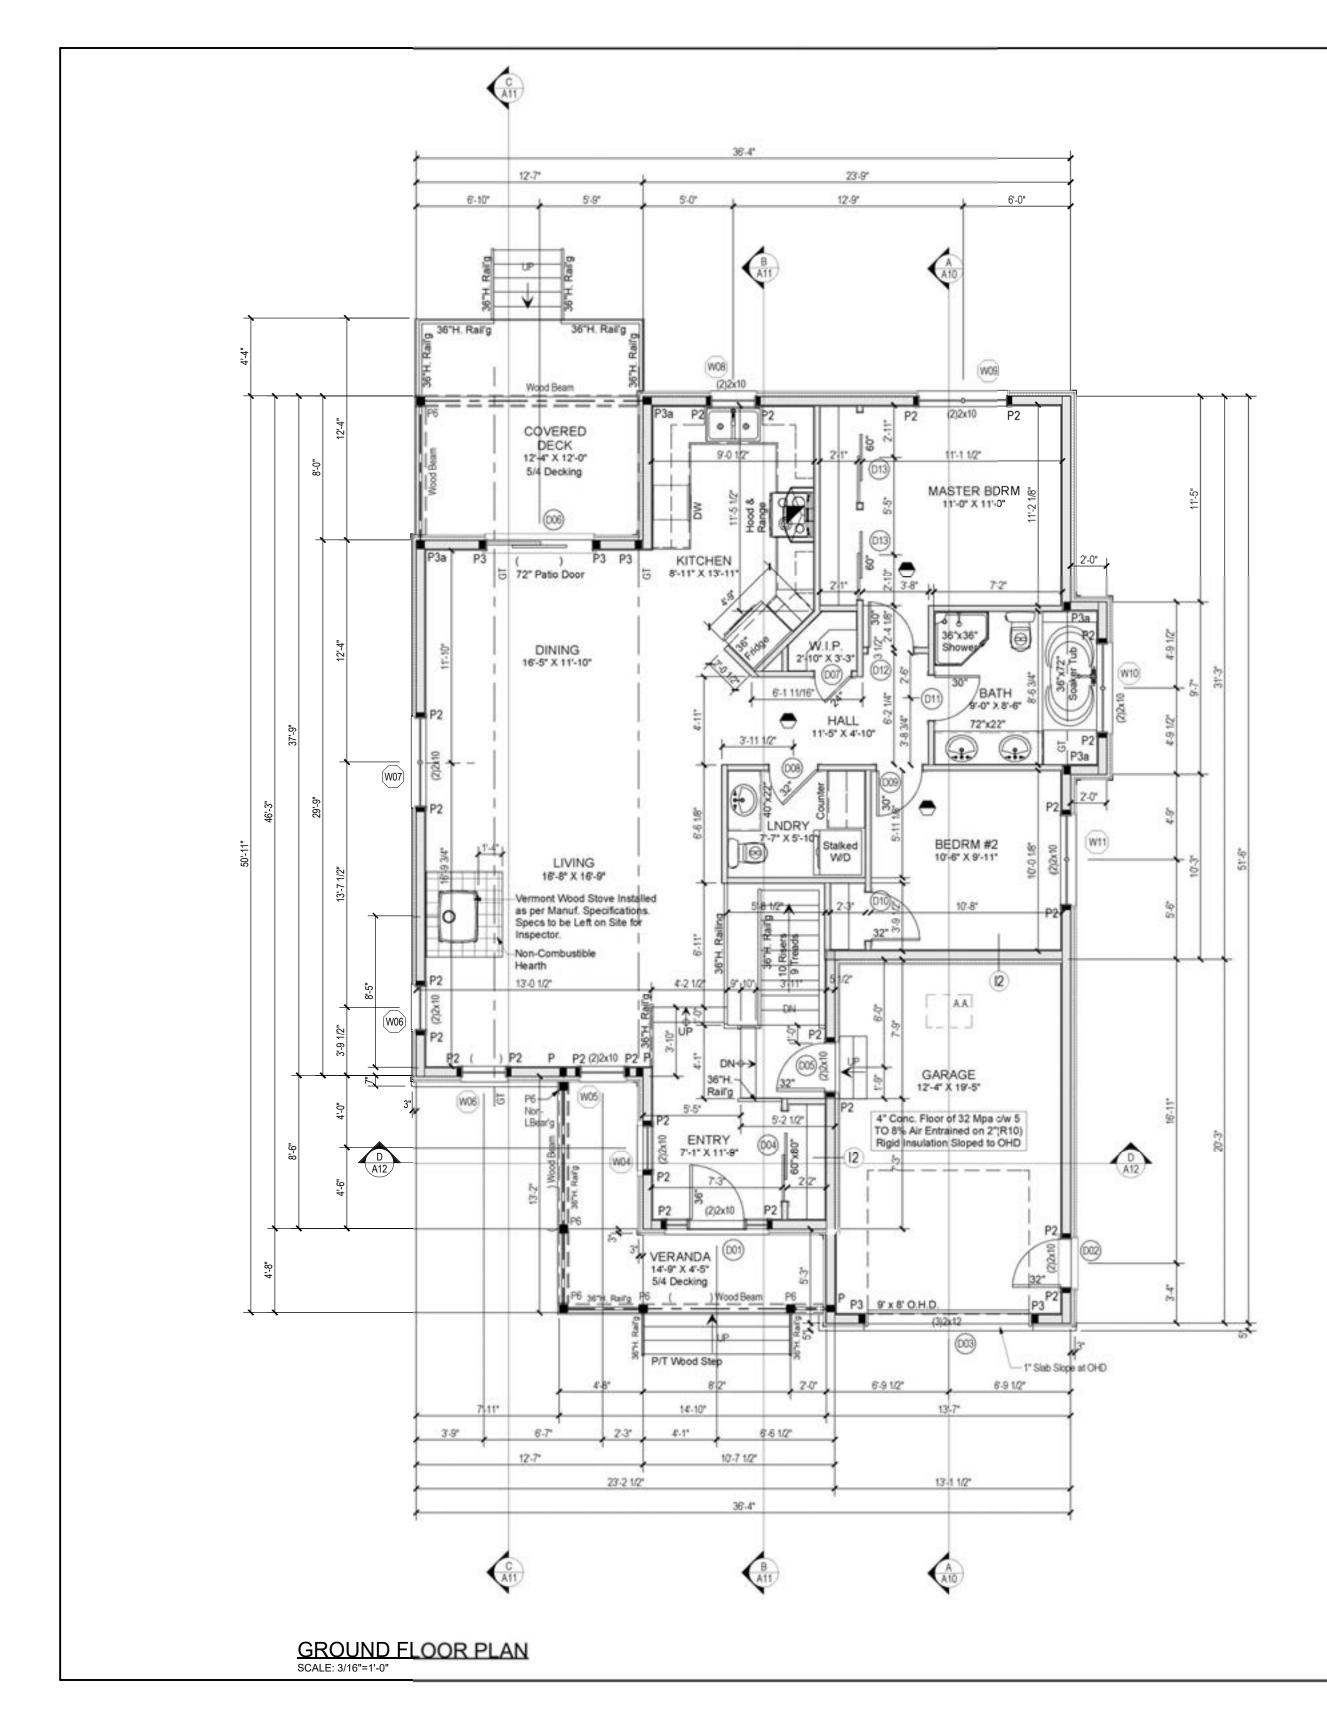ALL THE POSTS & LINTELS ARE IDENTIFIED ON THE FLOOR PLANS

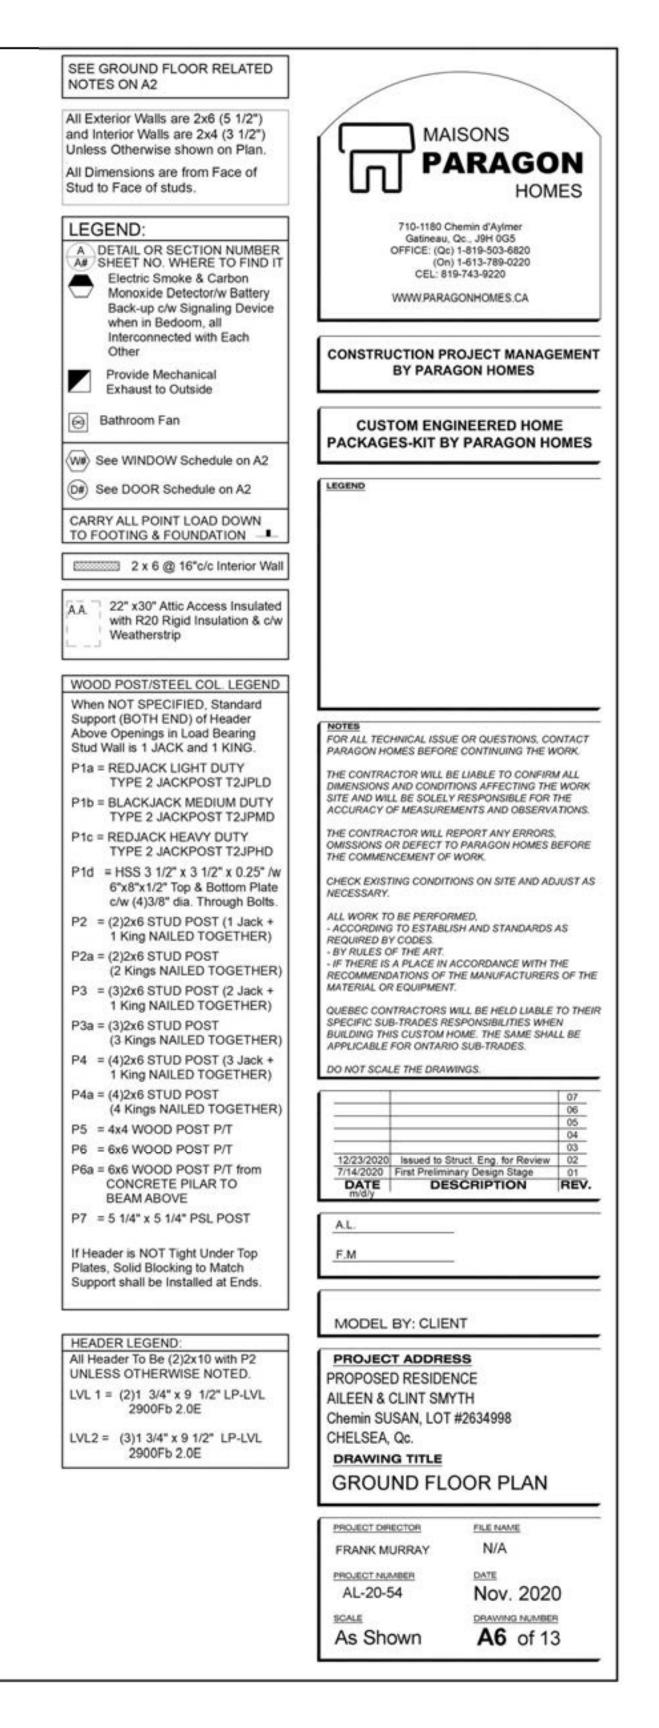MAXIMUM VENT

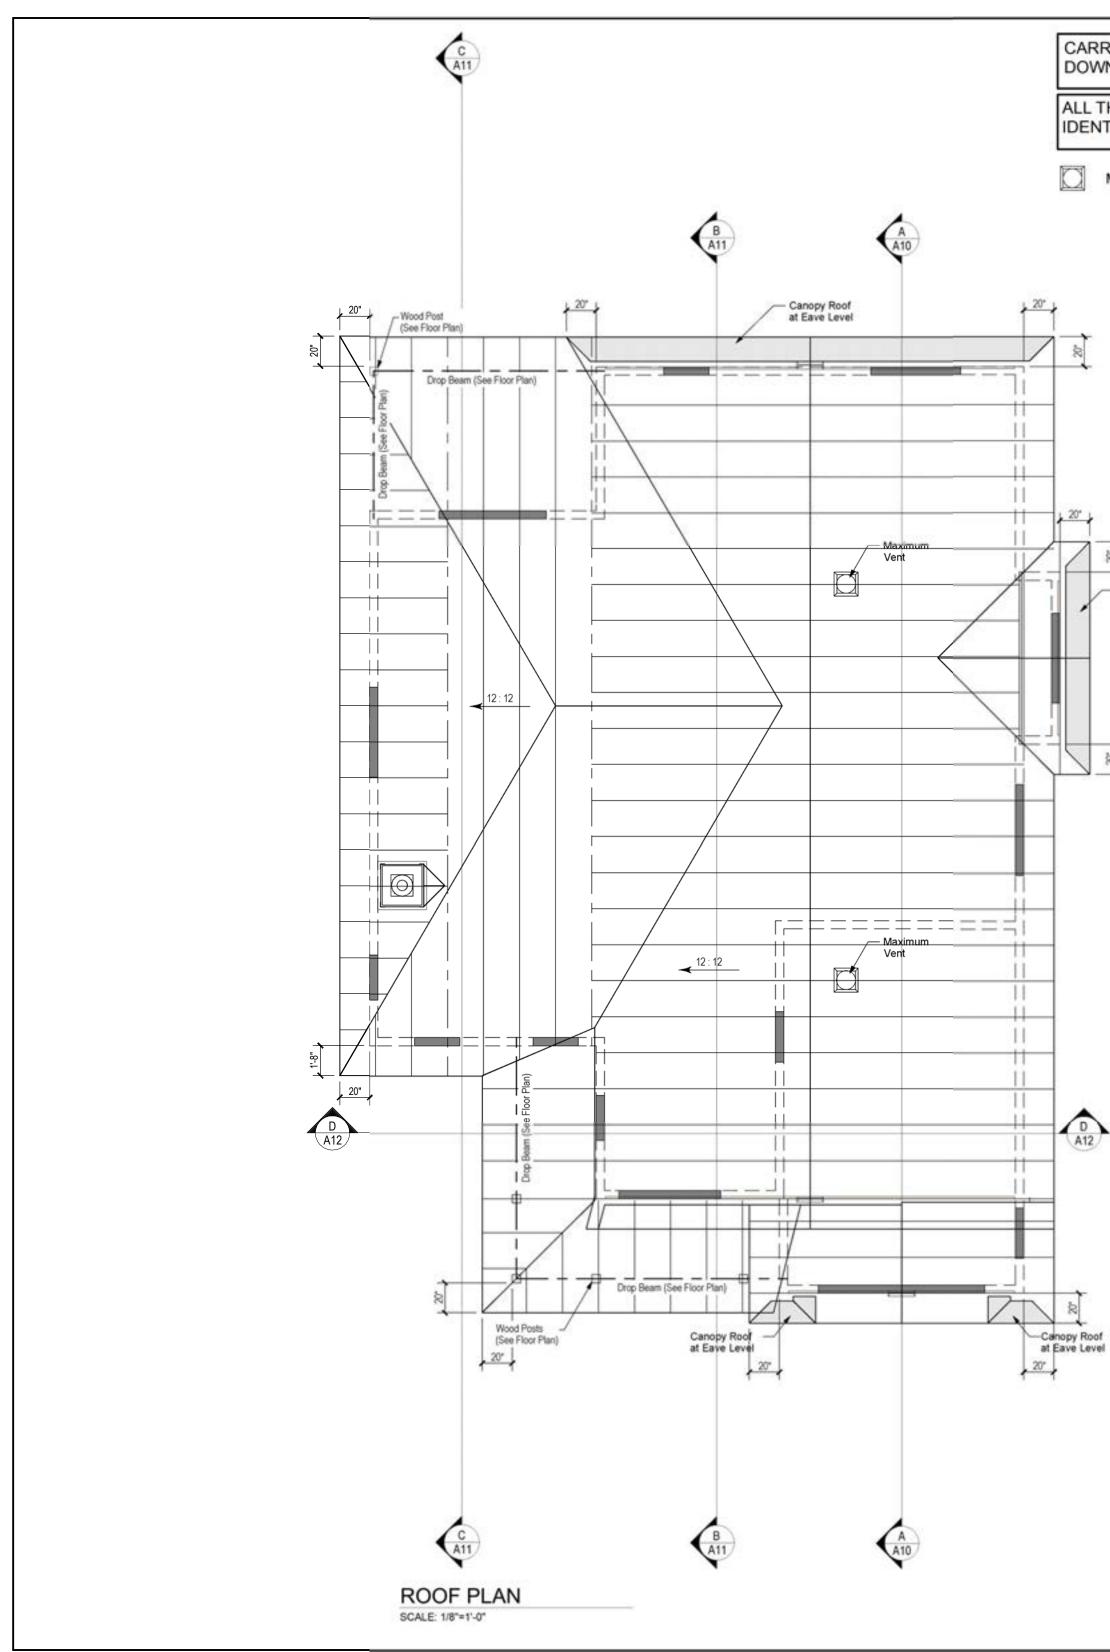1 20' - Canopy Roof at Eave Level

A12





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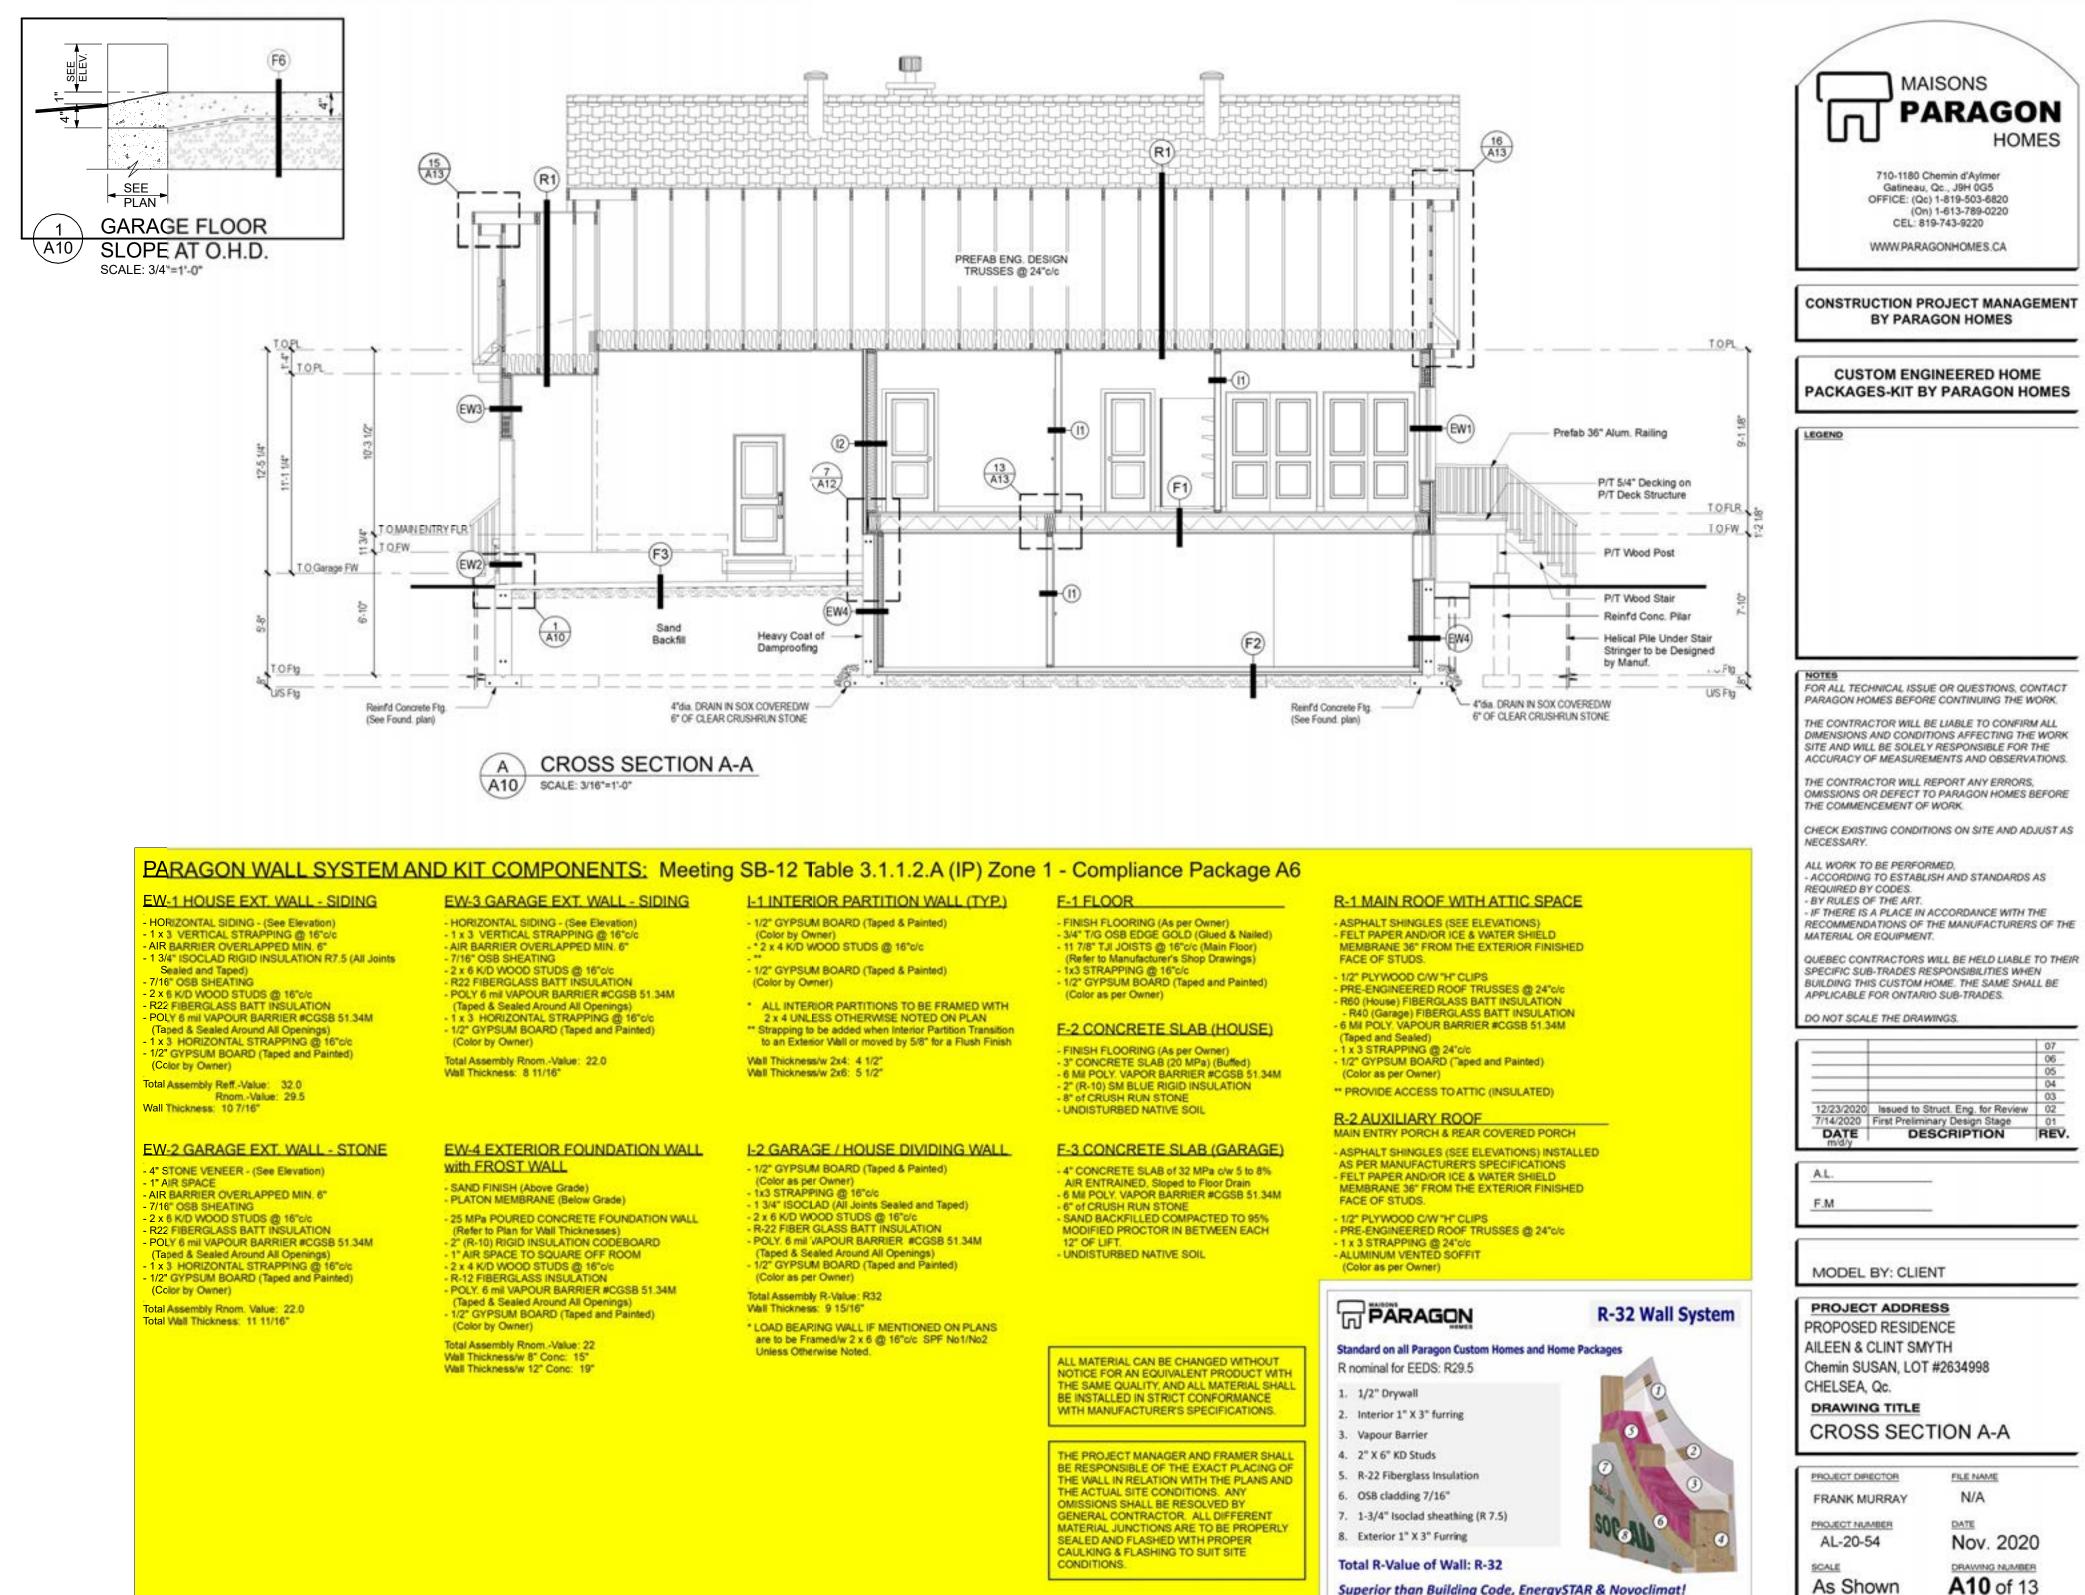
OUT AS SHOWN. TRUSSES TO BE

MAISONS PARAGON Π HOMES 710-1180 Chemin d'Aylmer Gatineau, Qc., J9H 0G5 OFFICE: (Qc) 1-819-503-6820 (On) 1-613-789-0220 CEL: 819-743-9220 WWW.PARAGONHOMES.CA CONSTRUCTION PROJECT MANAGEMENT BY PARAGON HOMES CUSTOM ENGINEERED HOME PACKAGES-KIT BY PARAGON HOMES LEGEND NOTES FOR ALL TECHNICAL ISSUE OR QUESTIONS, CONTACT PARAGON HOMES BEFORE CONTINUING THE WORK. THE CONTRACTOR WILL BE LIABLE TO CONFIRM ALL DIMENSIONS AND CONDITIONS AFFECTING THE WORK SITE AND WILL BE SOLELY RESPONSIBLE FOR THE ACCURACY OF MEASUREMENTS AND OBSERVATIONS. THE CONTRACTOR WILL REPORT ANY ERRORS, OMISSIONS OR DEFECT TO PARAGON HOMES BEFORE THE COMMENCEMENT OF WORK. CHECK EXISTING CONDITIONS ON SITE AND ADJUST AS NECESSARY. ALL WORK TO BE PERFORMED. - ACCORDING TO ESTABLISH AND STANDARDS AS REQUIRED BY CODES. - BY RULES OF THE ART. - IF THERE IS A PLACE IN ACCORDANCE WITH THE RECOMMENDATIONS OF THE MANUFACTURERS OF THE MATERIAL OR EQUIPMENT. QUEBEC CONTRACTORS WILL BE HELD LIABLE TO THEIR SPECIFIC SUB-TRADES RESPONSIBILITIES WHEN BUILDING THIS CUSTOM HOME. THE SAME SHALL BE APPLICABLE FOR ONTARIO SUB-TRADES. DO NOT SCALE THE DRAWINGS. 06 05 04 03 12/23/2020 Issued to Struct. Eng. for Review 02 7/14/2020 First Preliminary Design Stage 01 DESCRIPTION REV REV. A.L. F.M MODEL BY: CLIENT PROJECT ADDRESS PROPOSED RESIDENCE AILEEN & CLINT SMYTH Chemin SUSAN, LOT #2634998 CHELSEA, Qc. DRAWING TITLE ROOF PLAN


| PROJECT DIRECTOR | FILE NAME      |
|------------------|----------------|
| FRANK MURRAY     | N/A            |
| PROJECT NUMBER   | DATE           |
| AL-20-54         | Nov. 2020      |
| SCALE            | DRAWING NUMBER |
| As Shown         | A7 of 13       |



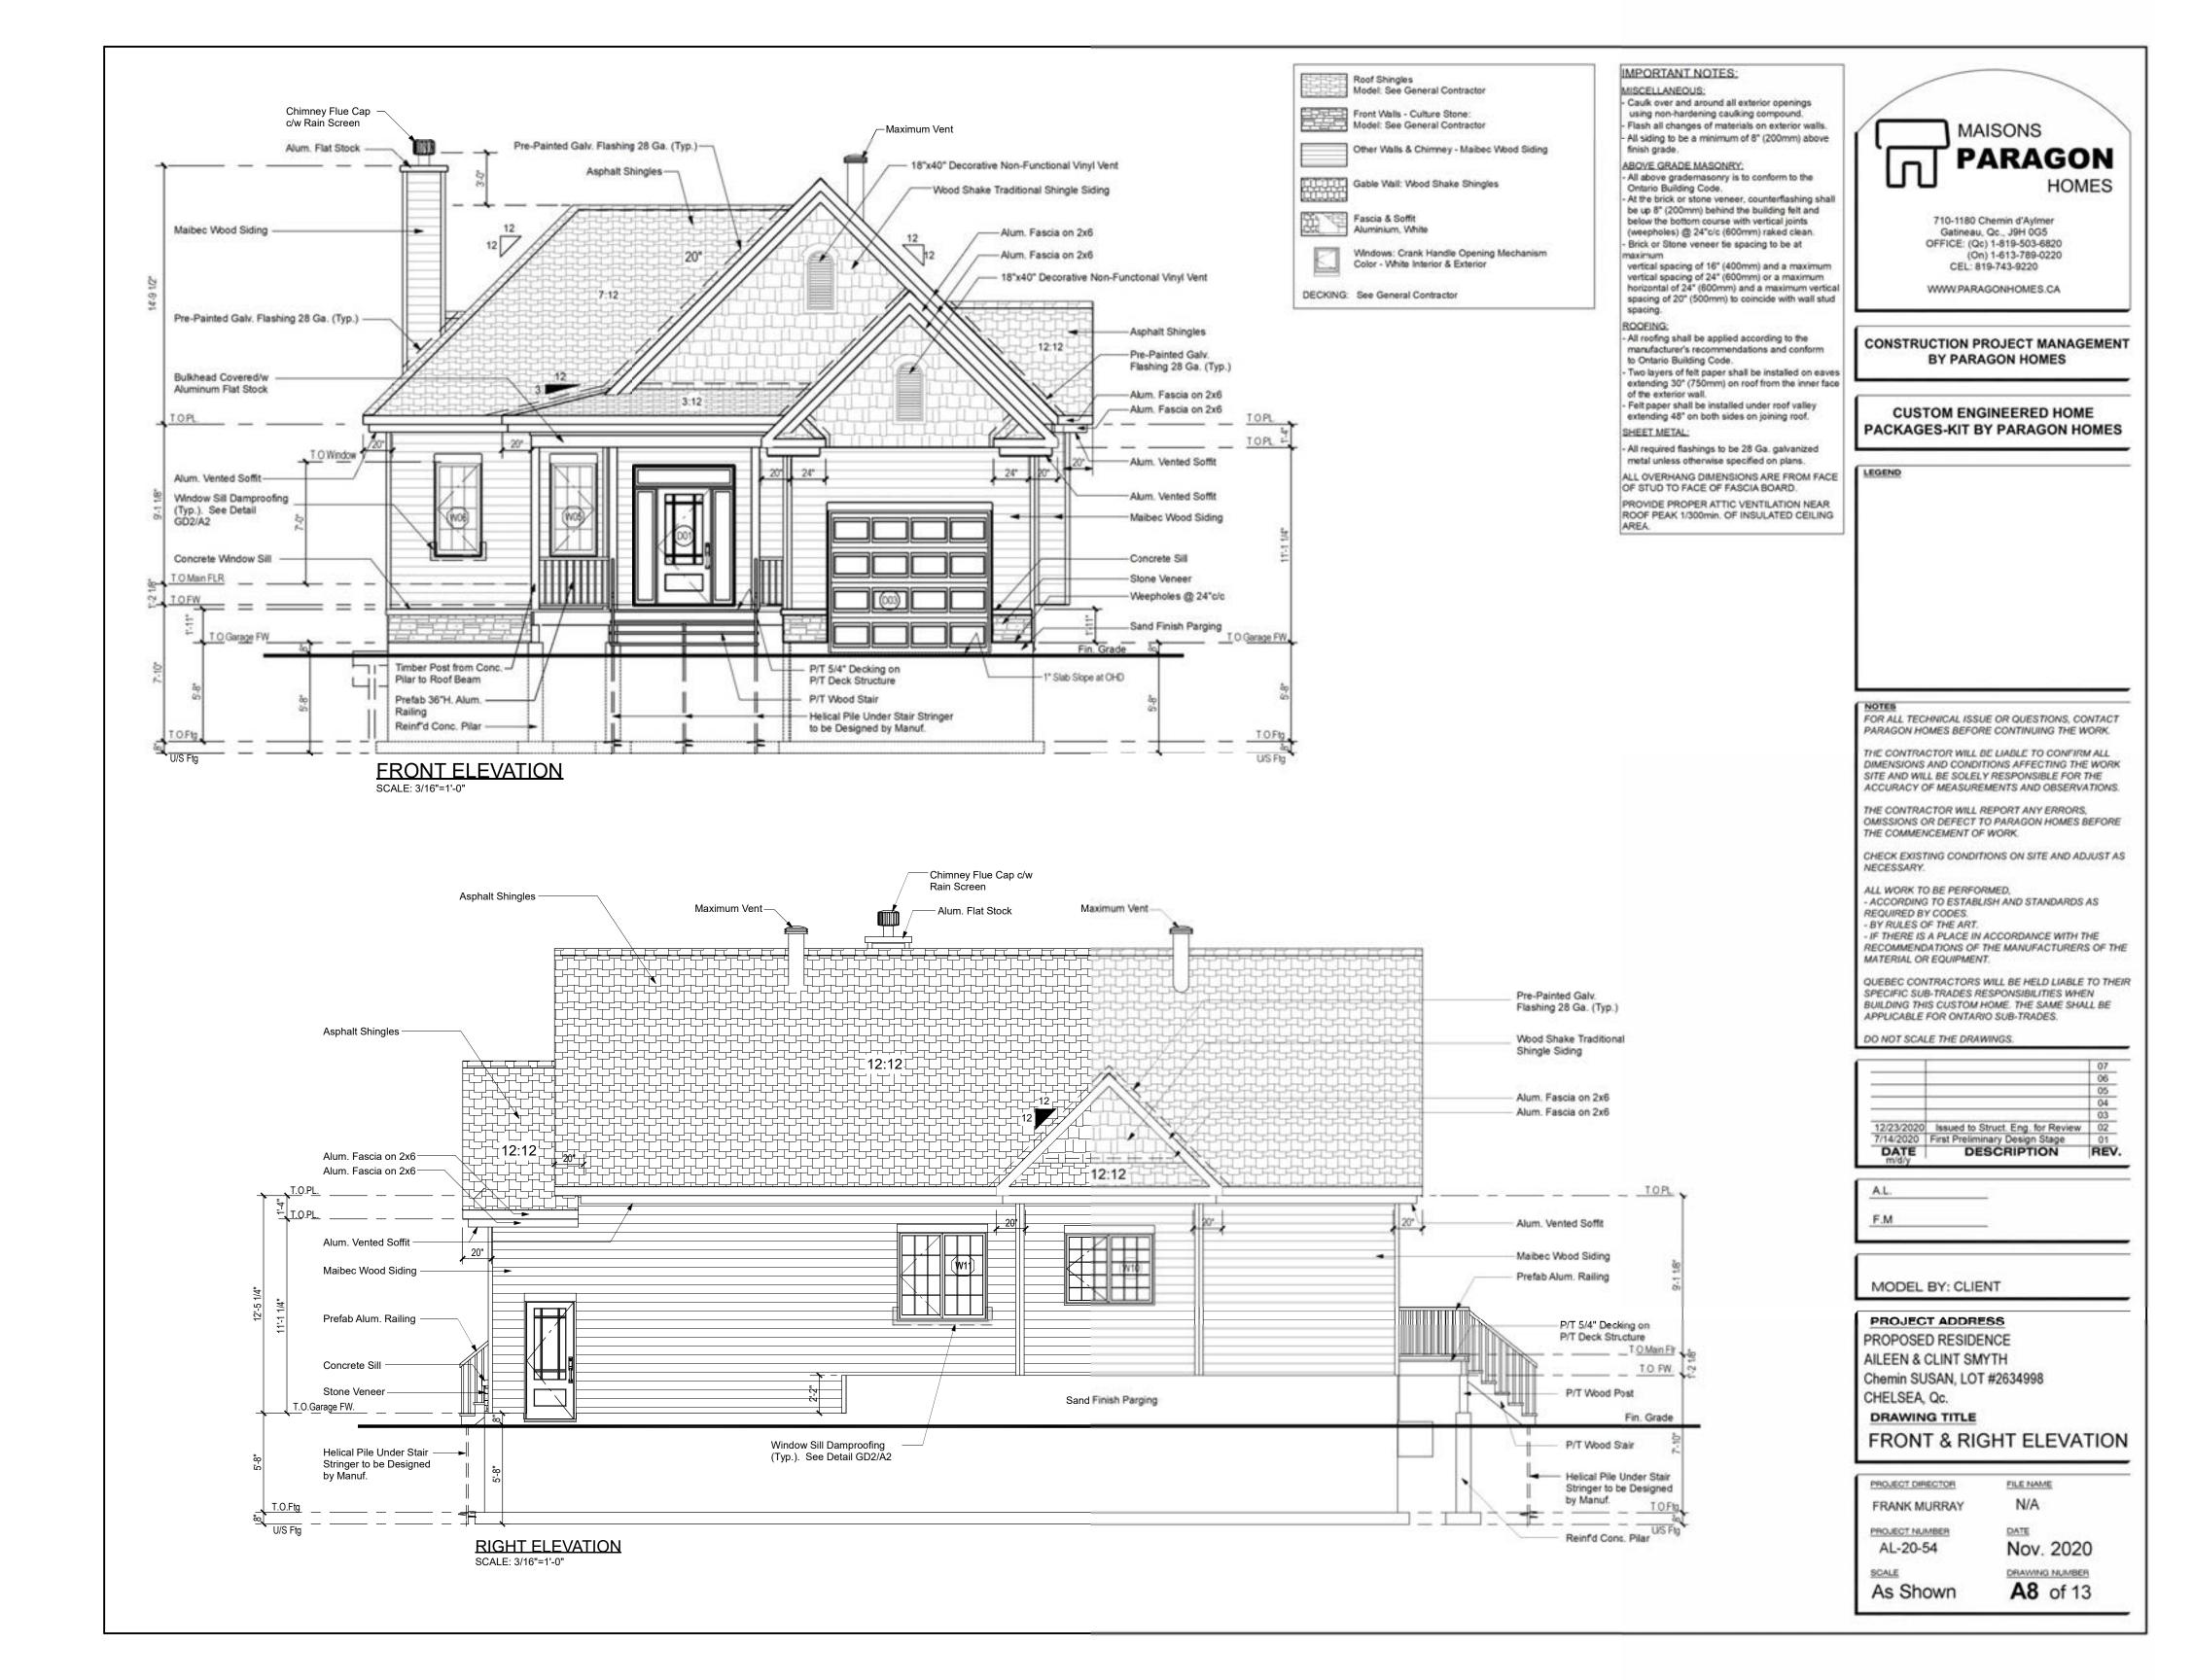


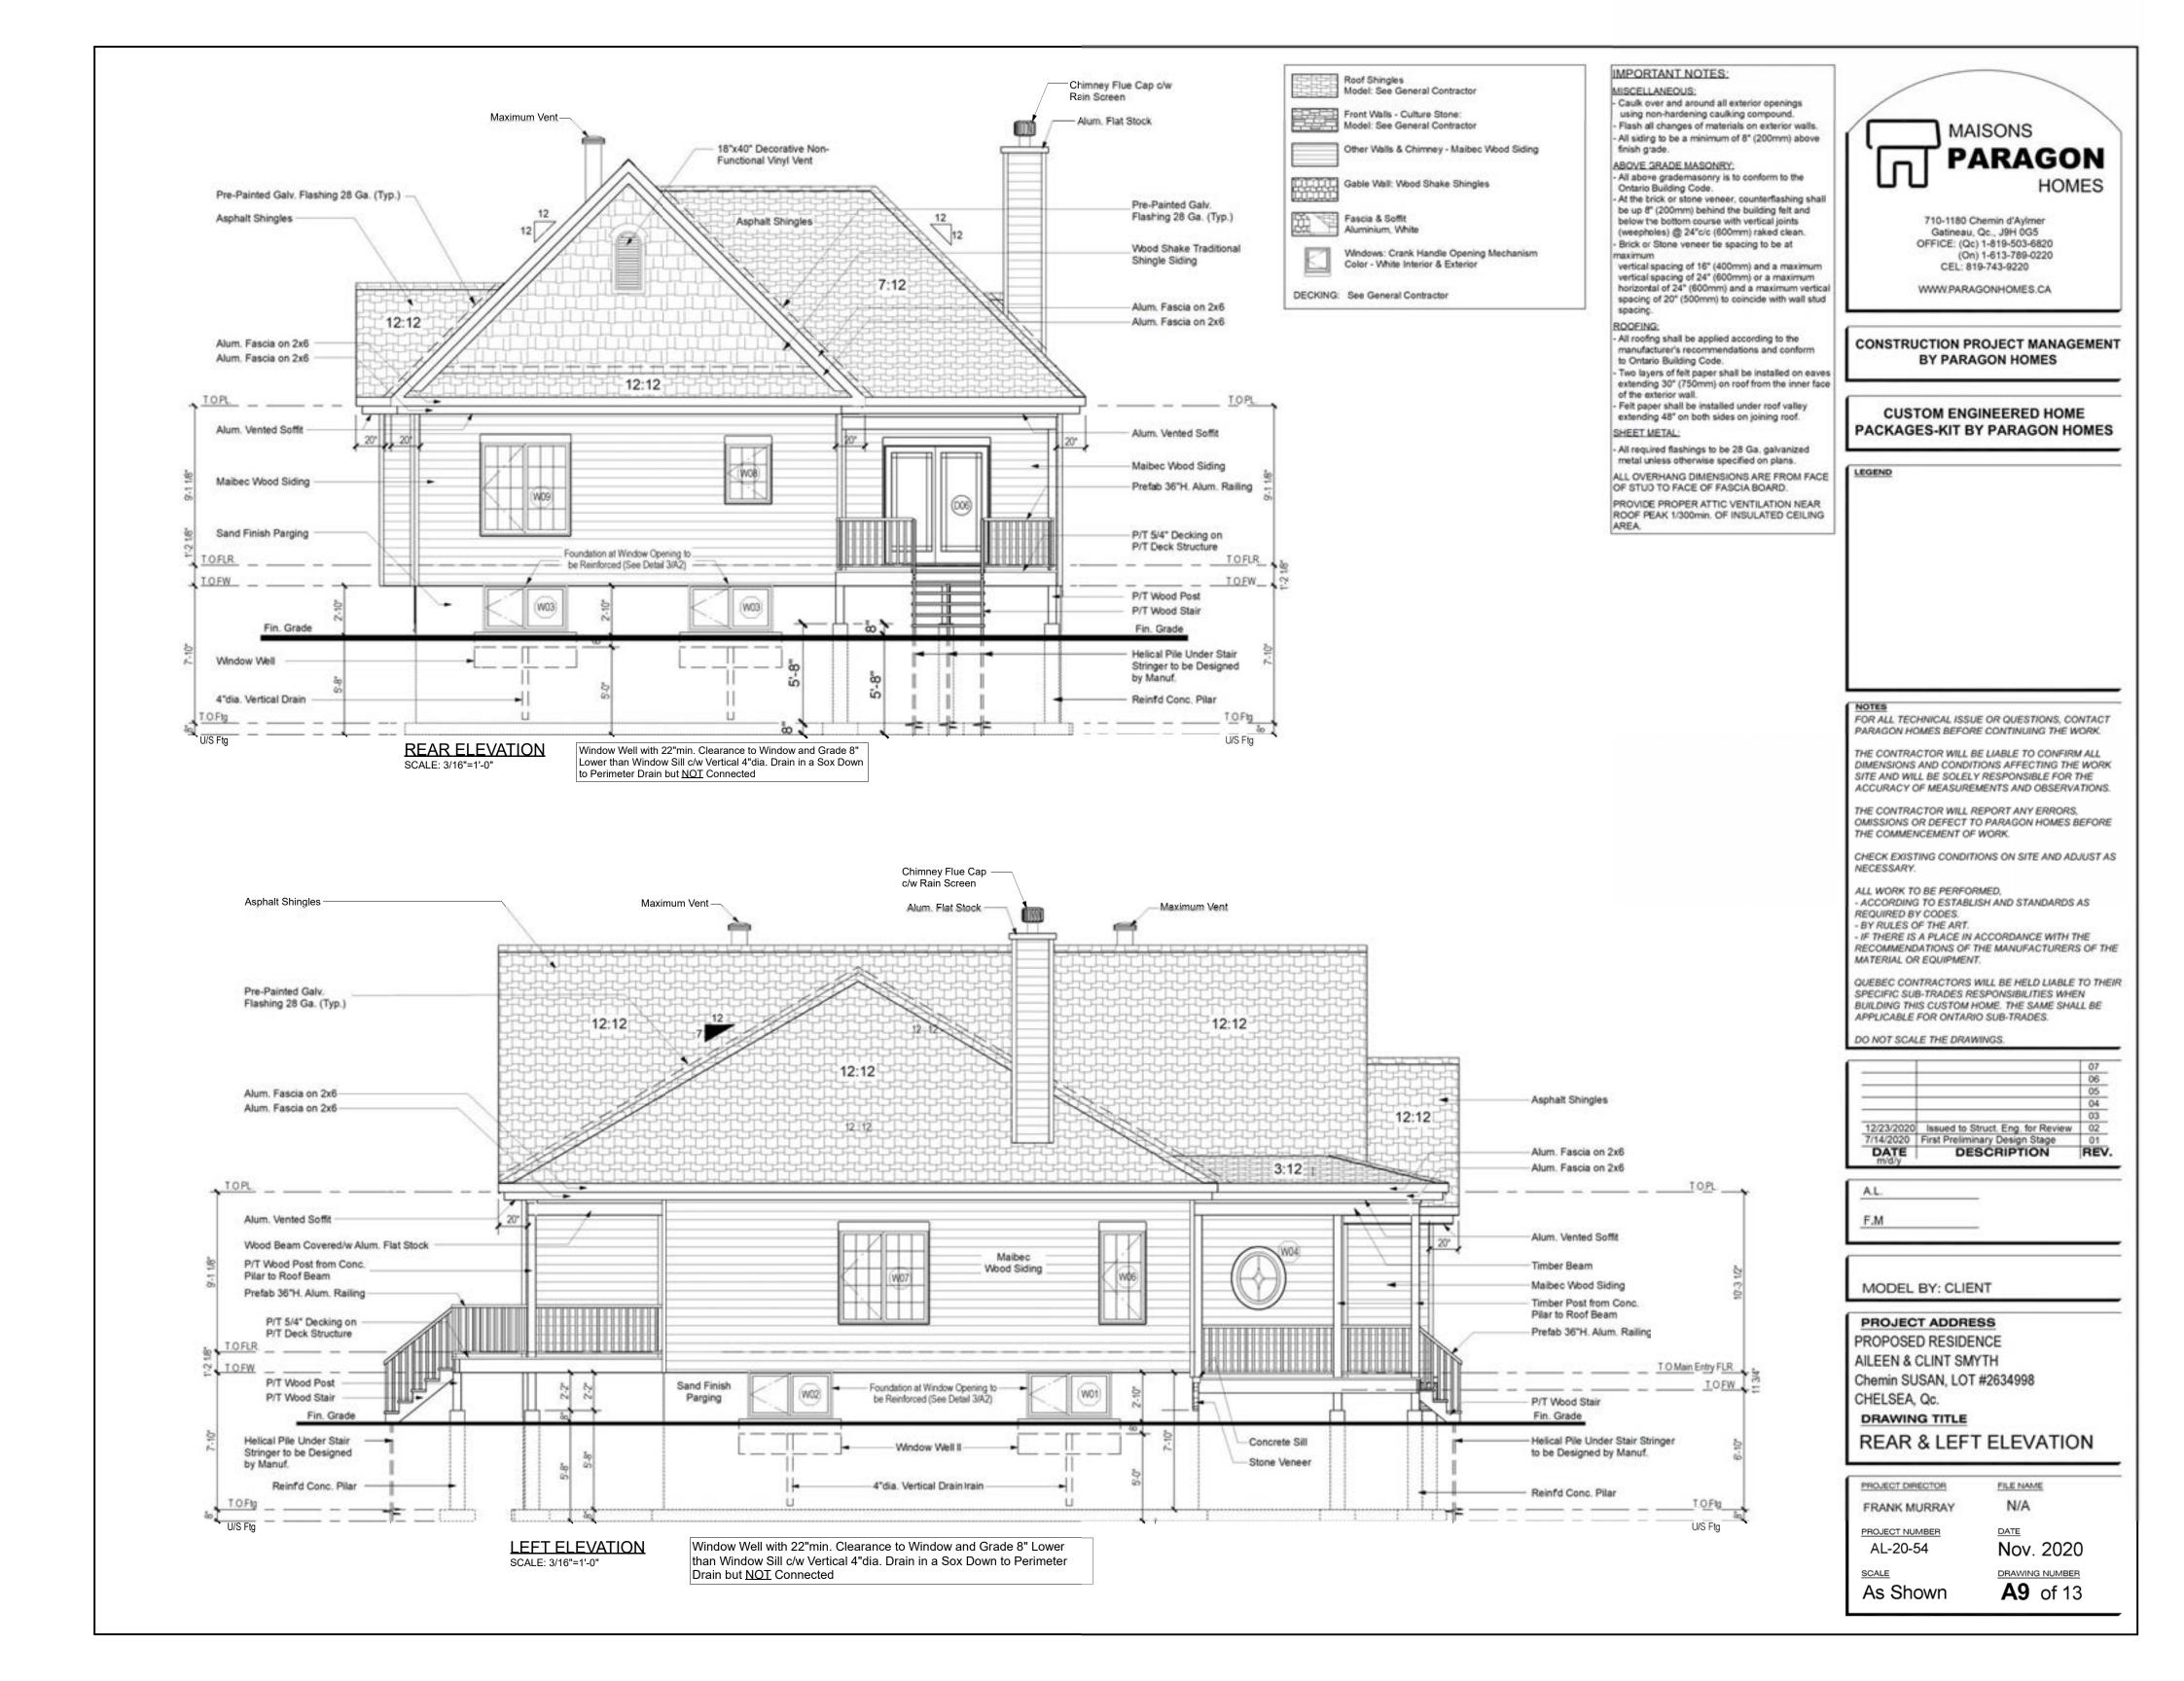

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| CUSTOM ENGINEERED HOME<br>PACKAGES-KIT BY PARAGON HOMES   |
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| <u>A.L.</u><br><u>F.M</u>   |
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| PROJECT DIRECTOR     FILE NAME       FRANK MURRAY     N/A       PROJECT NUMBER     DATE       AL-20-54     Nov. 2020       SCALE     DRAWING NUMBER       As Shown     A11 of 13  |

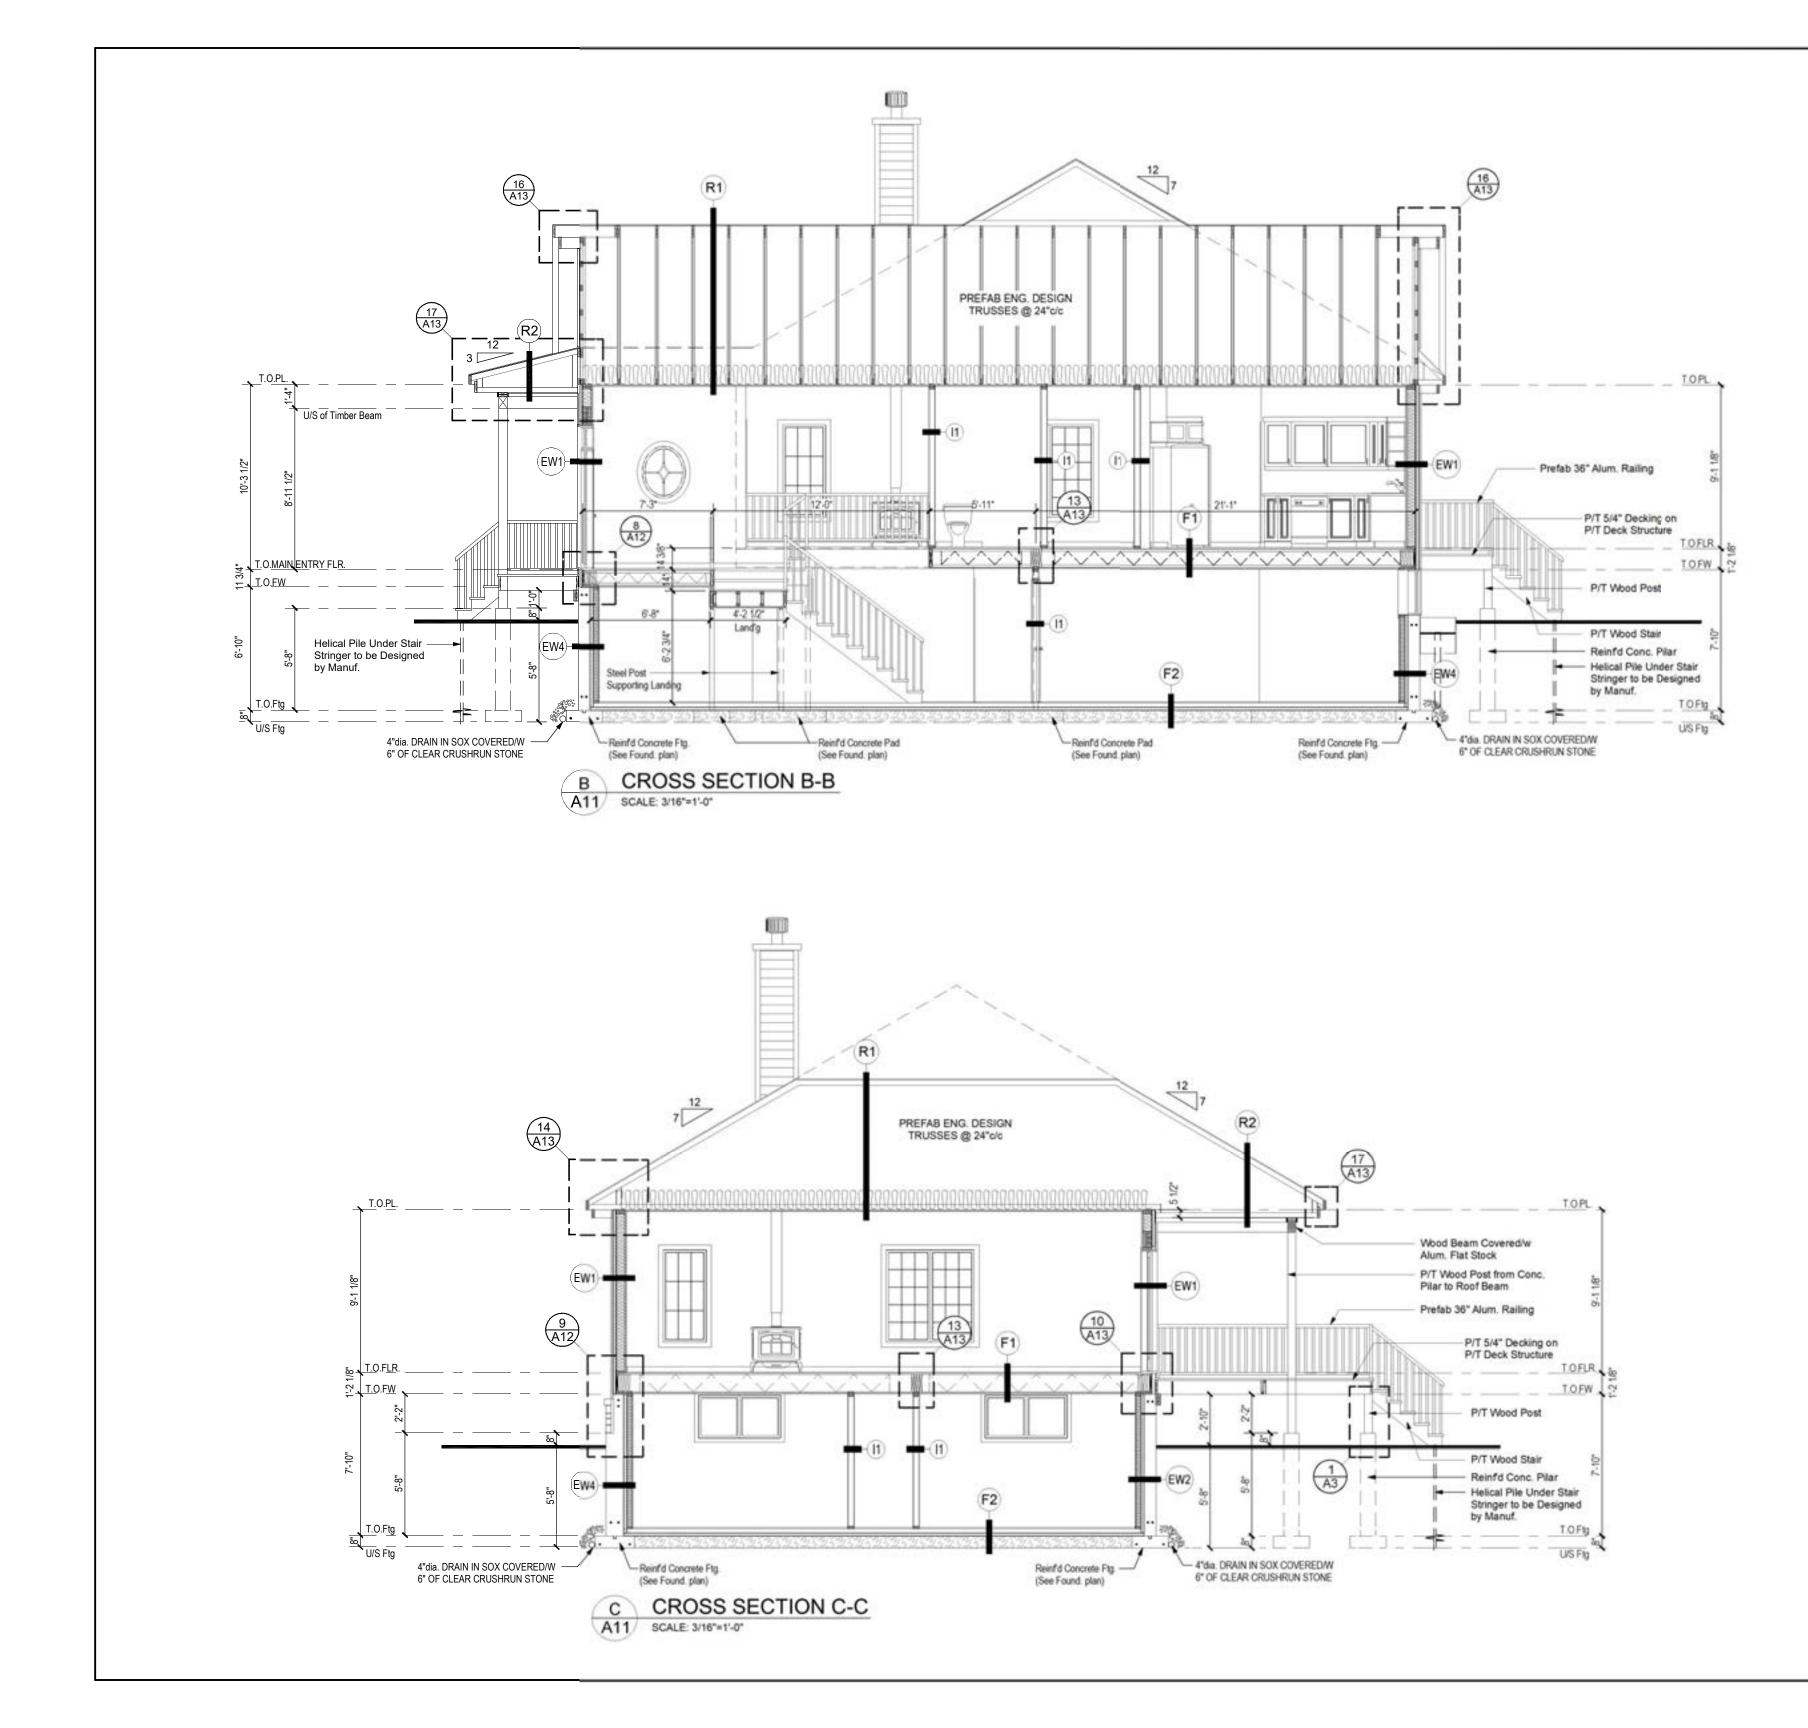

| MAISONS<br>PARAGON<br>HOMES<br>710-1180 Chemin d'Aylmer<br>Gatineau, Qc., J9H 0G5<br>OFFICE: (Qc) 1-819-503-6820<br>(On) 1-613-789-0220<br>CEL: 819-743-9220<br>WWW.PARAGONHOMES.CA   |
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| PROJECT DIFFECTOR     FILE NAME       FRANK MURRAY     N/A       PROJECT NUMBER     DATE       AL-20-54     DOV. 2020       SCALE     DRAWING NUMBER       As Shown     A12 of 13   |

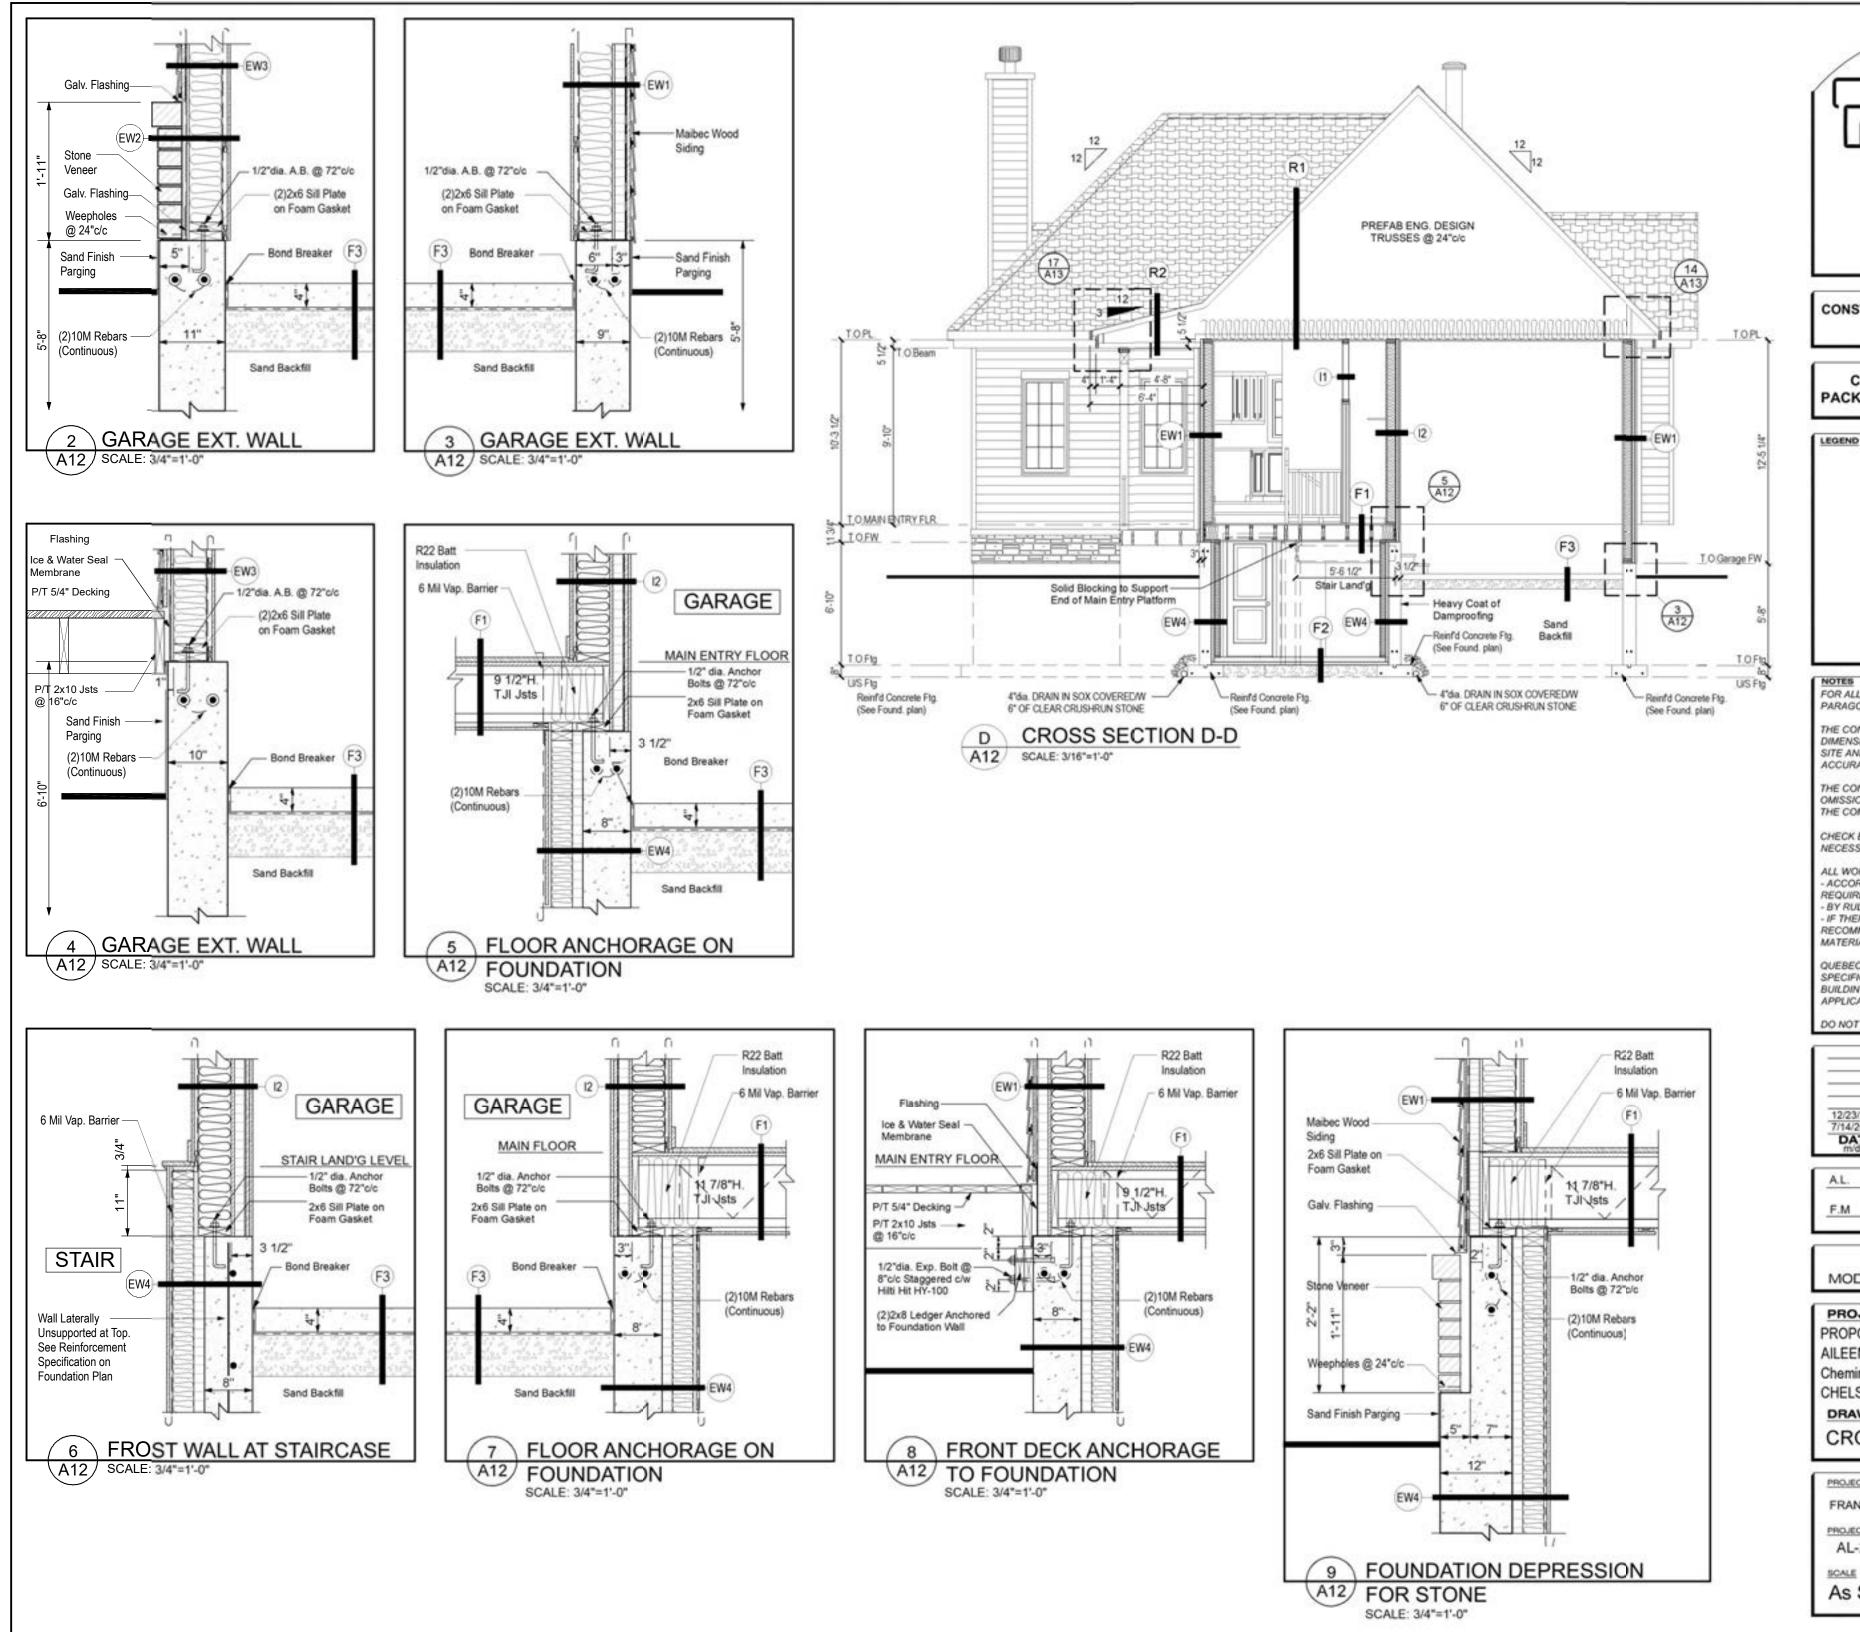